

## POOL DECK AND THICKENED SLAB REINFORCEMENT DETAILS




SCALE - 1/8"=1'-0"  
REF:SI01, S301 & S302

ALL BARS IN THIS DRAWING  
ASTM A615 GRADE 60  
BLACK UNCOATED

SLAB SCHEDULE		
SLAB / MAT		
12" THK.LESS	12" THK.GREATER	
ALL	BOT	OTHERS
20"	20"	25"
25"	25"	33"
32"	32"	41"
38"	38"	49"
82"	82"	106"
94"	94"	121"
109"	109"	137"
119"	119"	154"
132"	132"	171"

WALLS		
E	VERT.BARS	HORIZ.BARS
6	20"	25"
+	25"	33"
5	32"	41"
0	38"	49"
7	55"	71"
3	63"	81"
9	71"	91"
0	80"	103"
	88"	114"

MESH SCHEDULE				
ELEMENT	MESH SIZE	SHEETS	AREA	REMARK
5" THK POOL DECK	6x6 - W2.9XW2.9 WWF	80	7450 SQ.FT	8'-0" X 15'-0" SHEET SIZE (15% L AP ADDED)

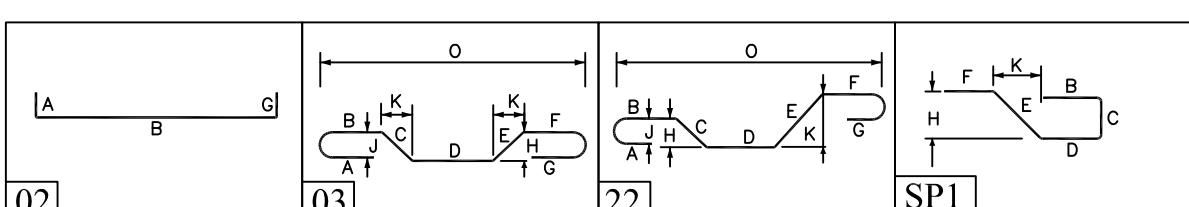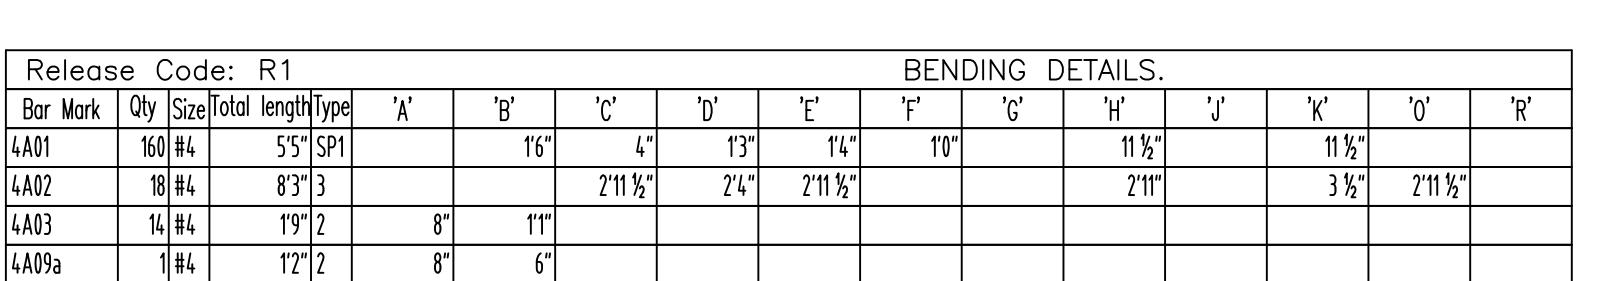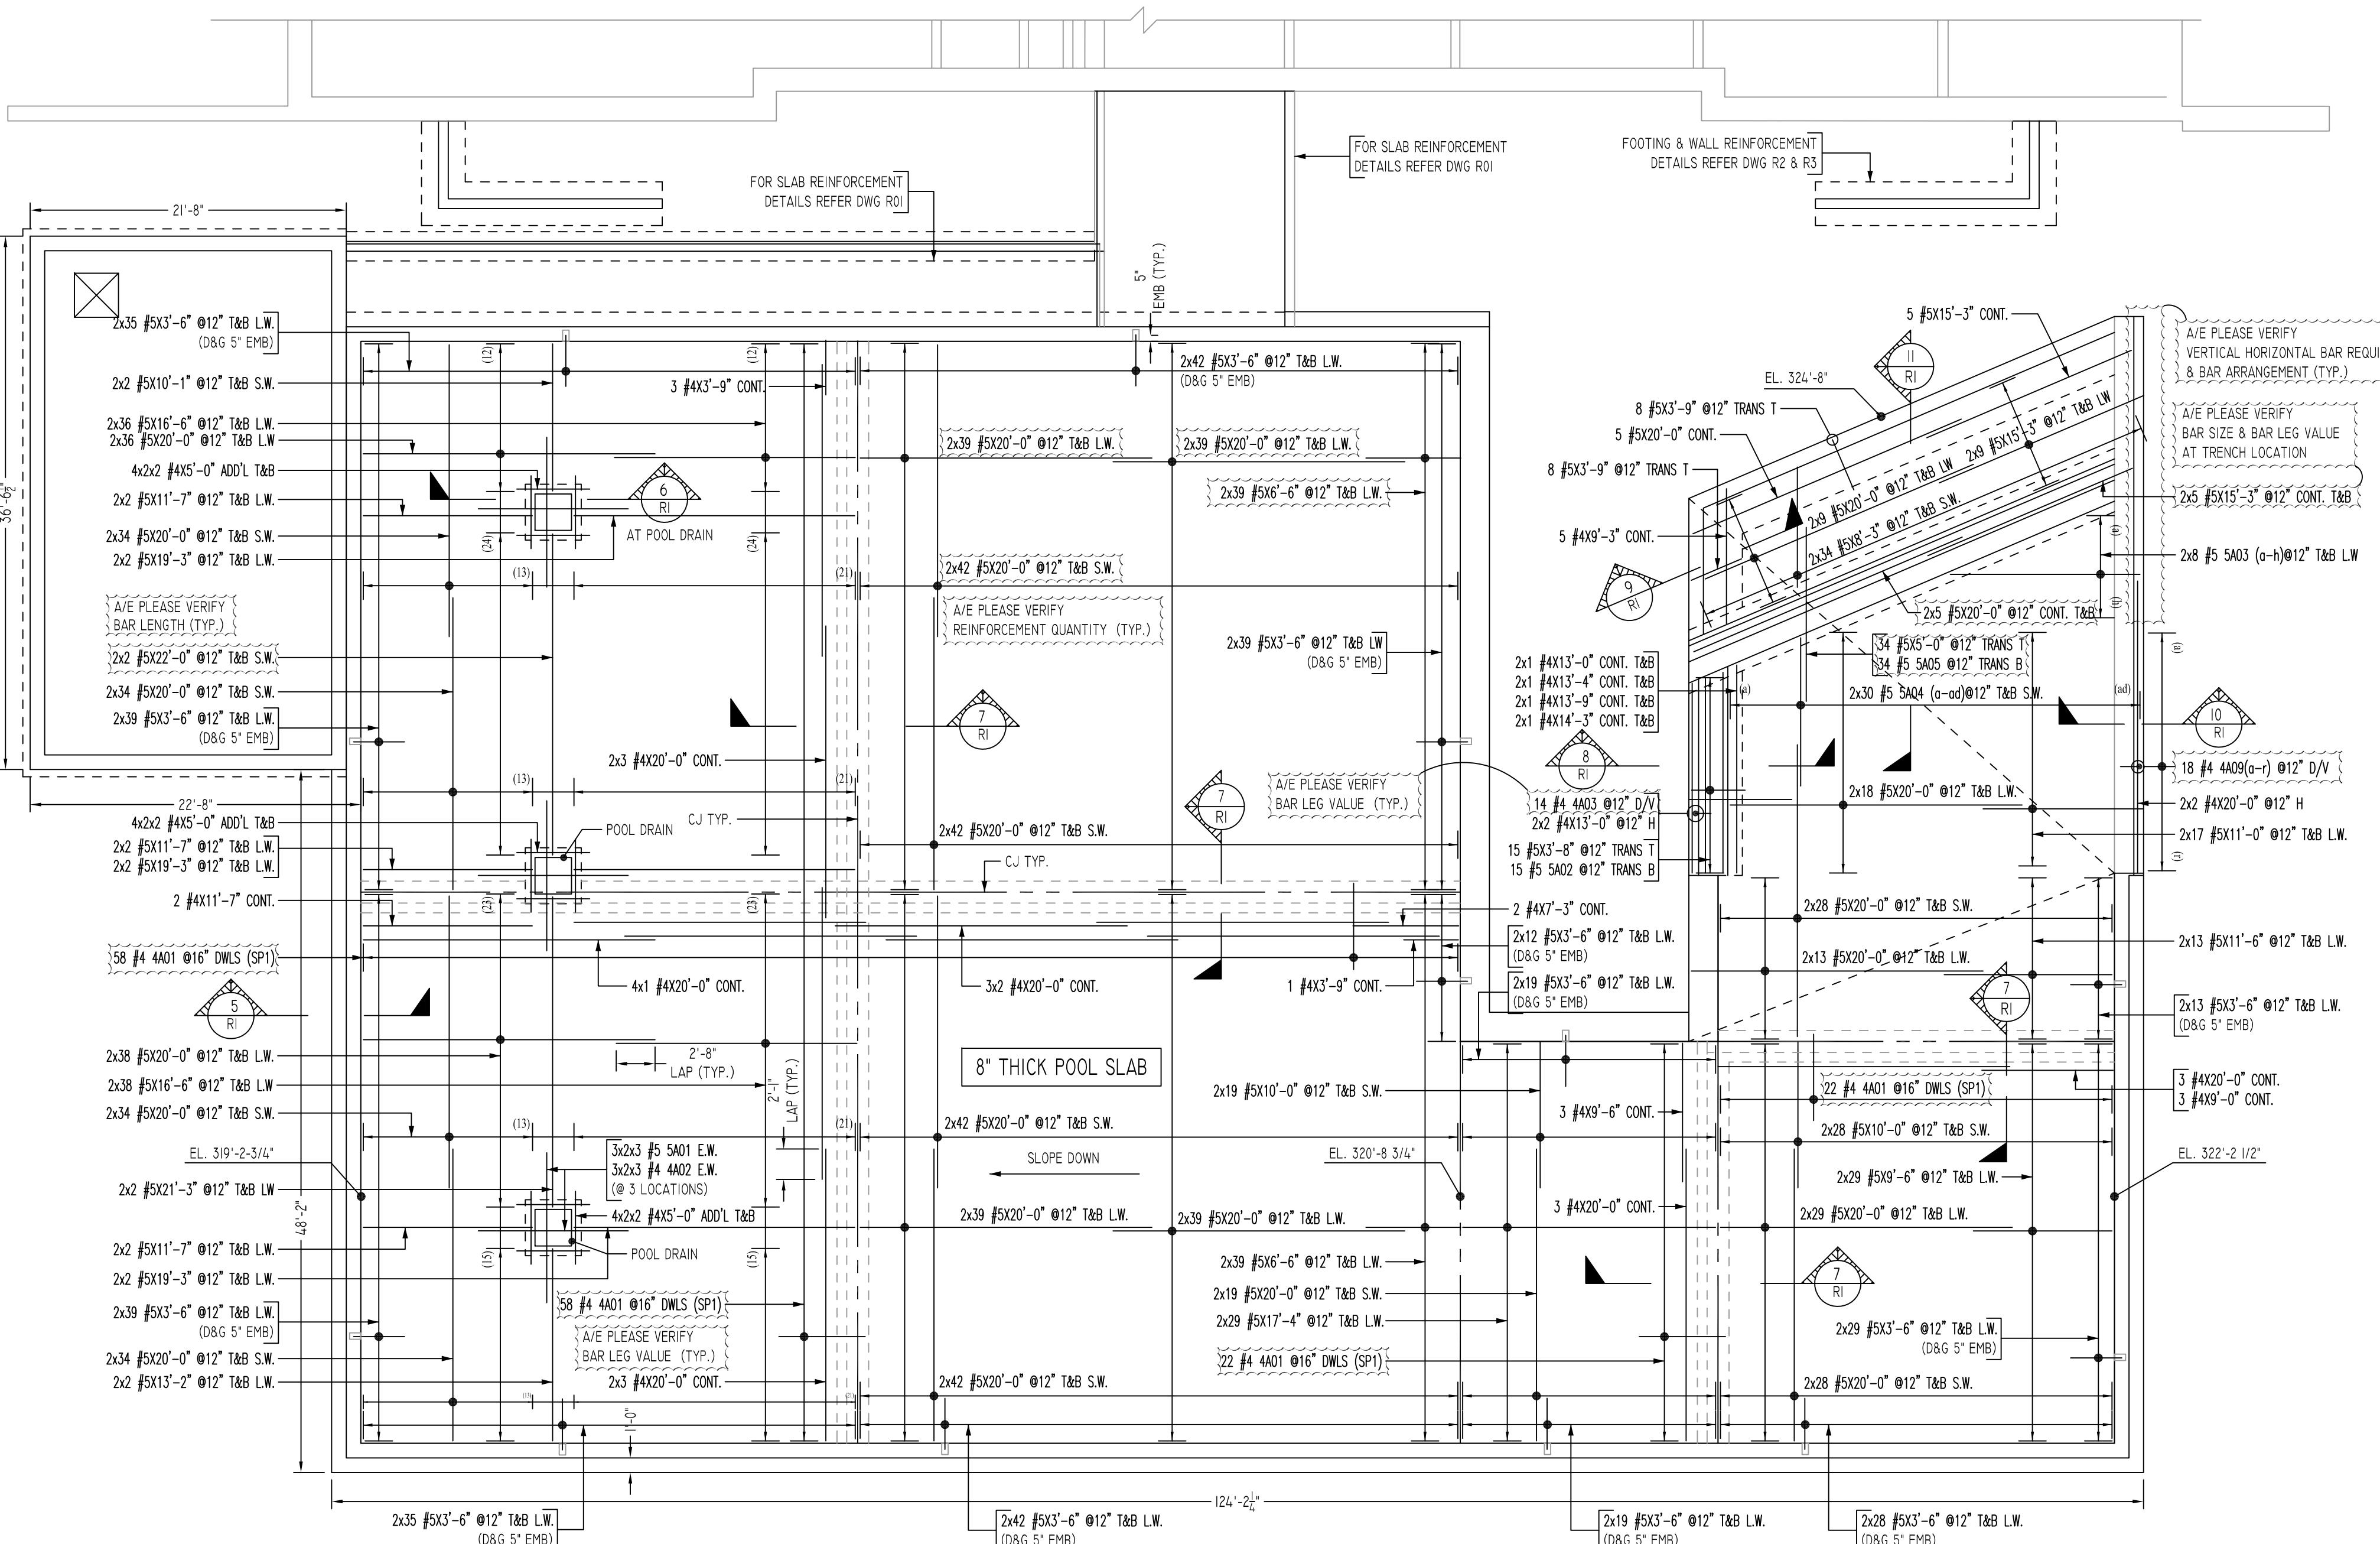






LAP SCHEDULE			
SIZE	SLAB / MAT		
	I2" THK.LESS	I2" THK.GREATER	
	ALL	BOT	OTHERS
#3	20"	20"	25"
#4	25"	25"	33"
#5	32"	32"	41"
#6	38"	38"	49"
#7	82"	82"	106"
#8	94"	94"	121"
#9	109"	109"	137"
#10	119"	119"	154"
#11	132"	132"	171"

LAP SCHEDULE		
WALLS		
SIZE	VERT.BARS	HORIZ.BARS
#3	20"	25"
#4	25"	33"
#5	32"	41"
#6	38"	49"
#7	55"	71"
#8	63"	81"
#9	71"	91"
#10	80"	103"
#11	88"	114"


ALL BARS IN THIS DRAWING  
ASTM A615 GRADE 60  
BLACK UNCOATED




abbreviations:	
I.=Inside Face	OPNG=Op
O.=Outside Face	BAL: Balan
F.=Each Face	BTW: Betw
WL=Dowel	CJ=Constr
V.=Vertical	CLR: CLR
H.=Horizontal	CMU= Co
B.=Corner Bar	CONT.=C
OWL.=Slab Dowel	EA.=Each
W.=Each Way	Elev.=Elev
BOT.=Bottom	EMB=Em
T.=Top	SW = Sho
DWL= Masonry Dowel	LW=Long
B.=Bond Beam	(BL)=Blac
A.T: Alternate	(EP)=Epoxy
approx: Approximate	(GA)= Ga

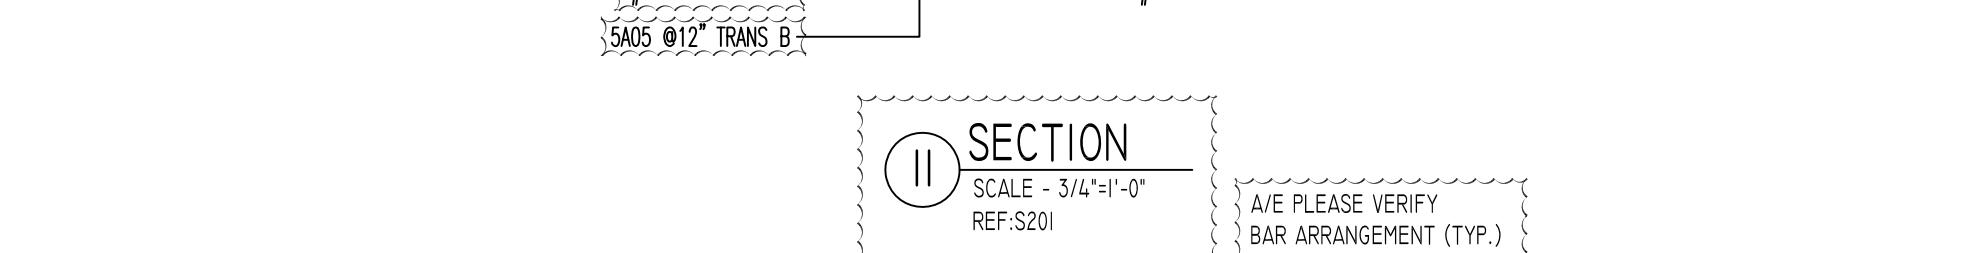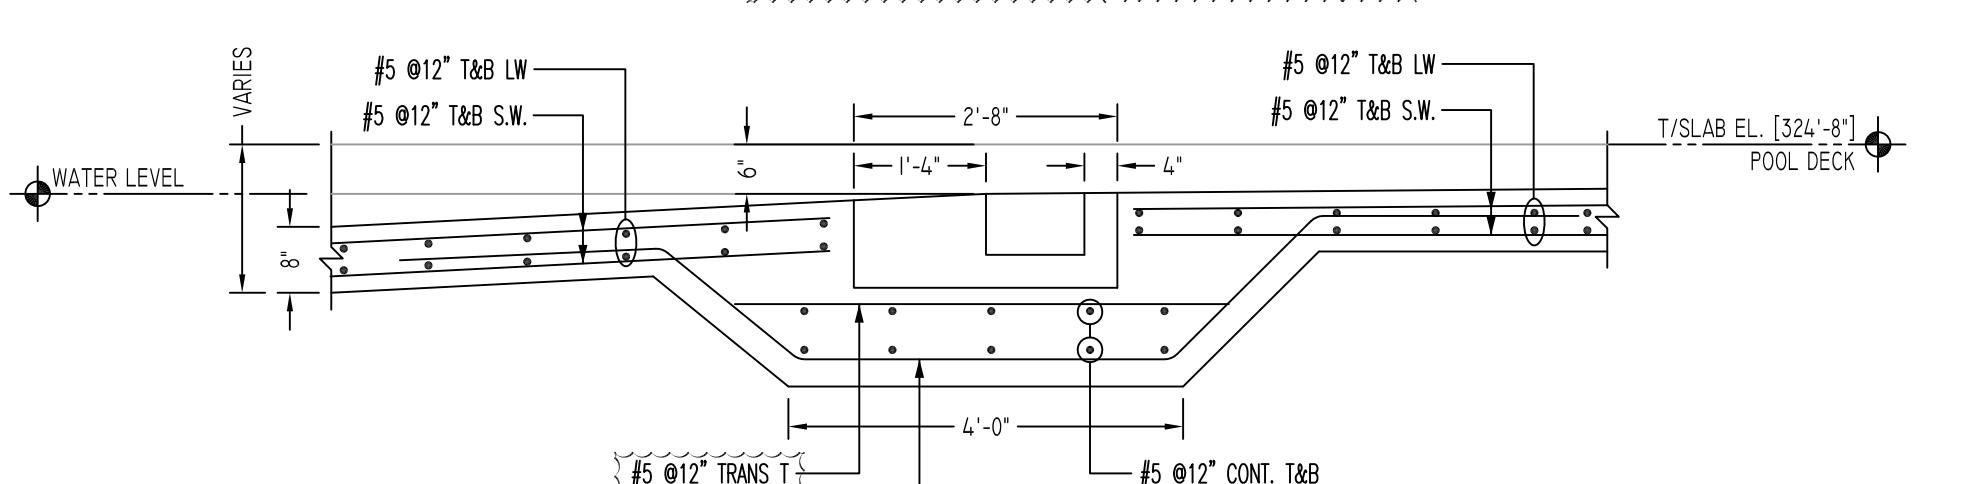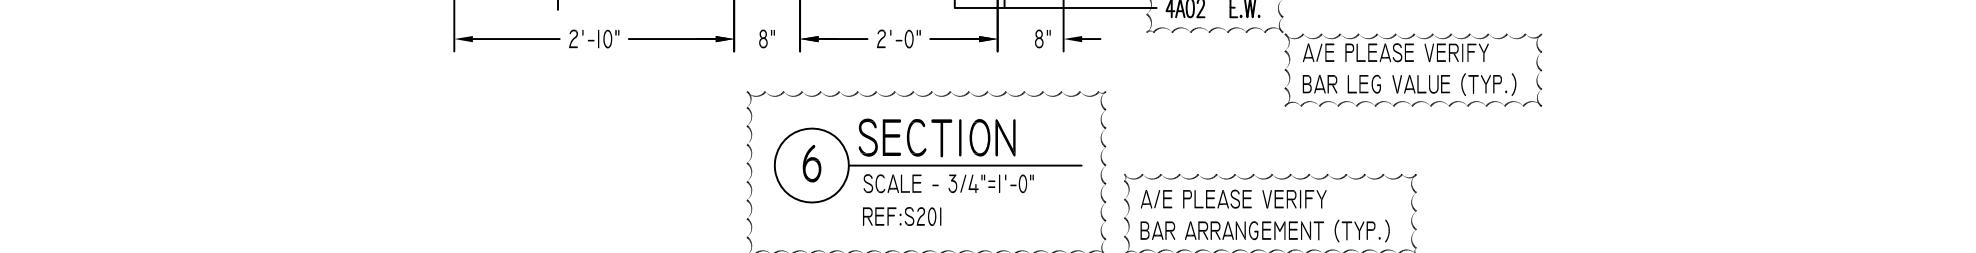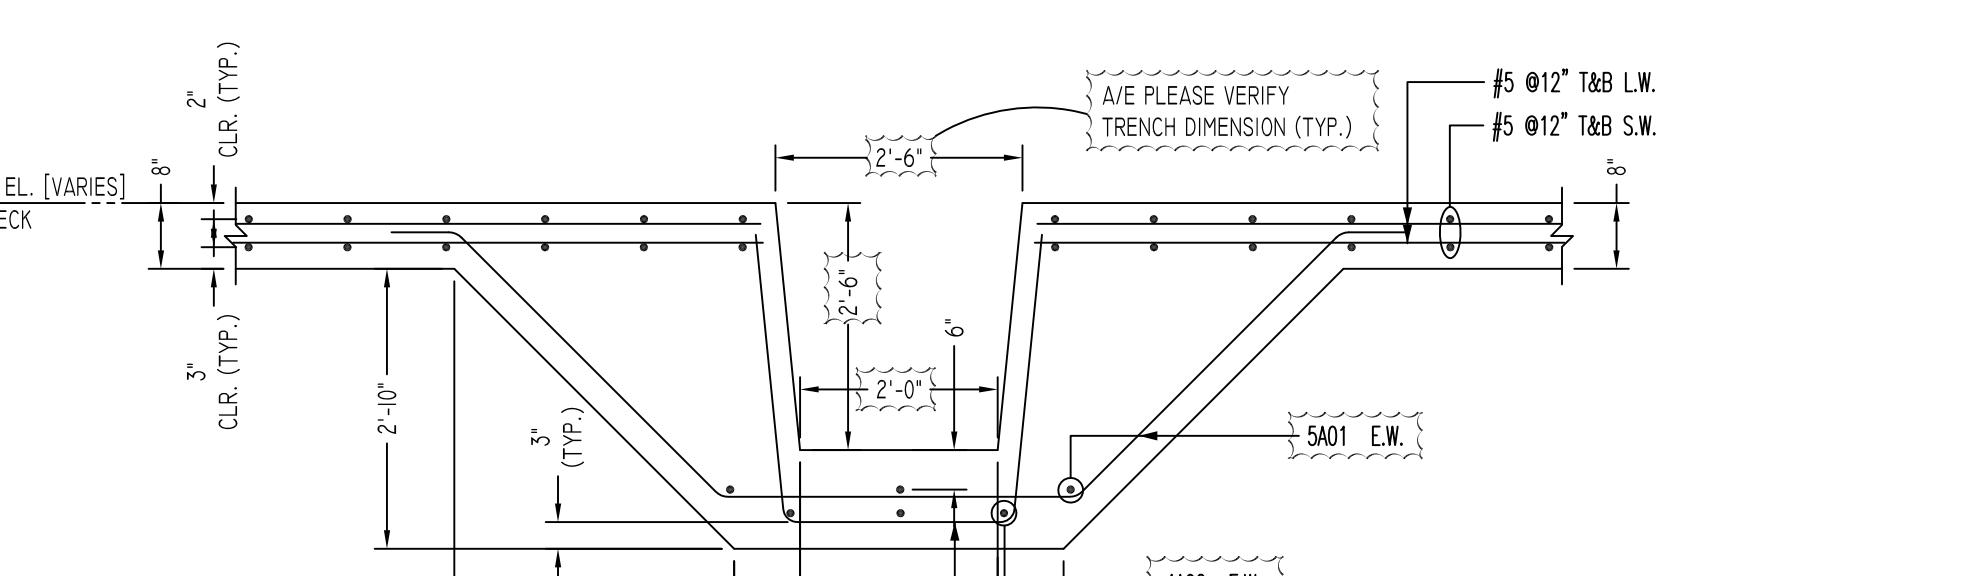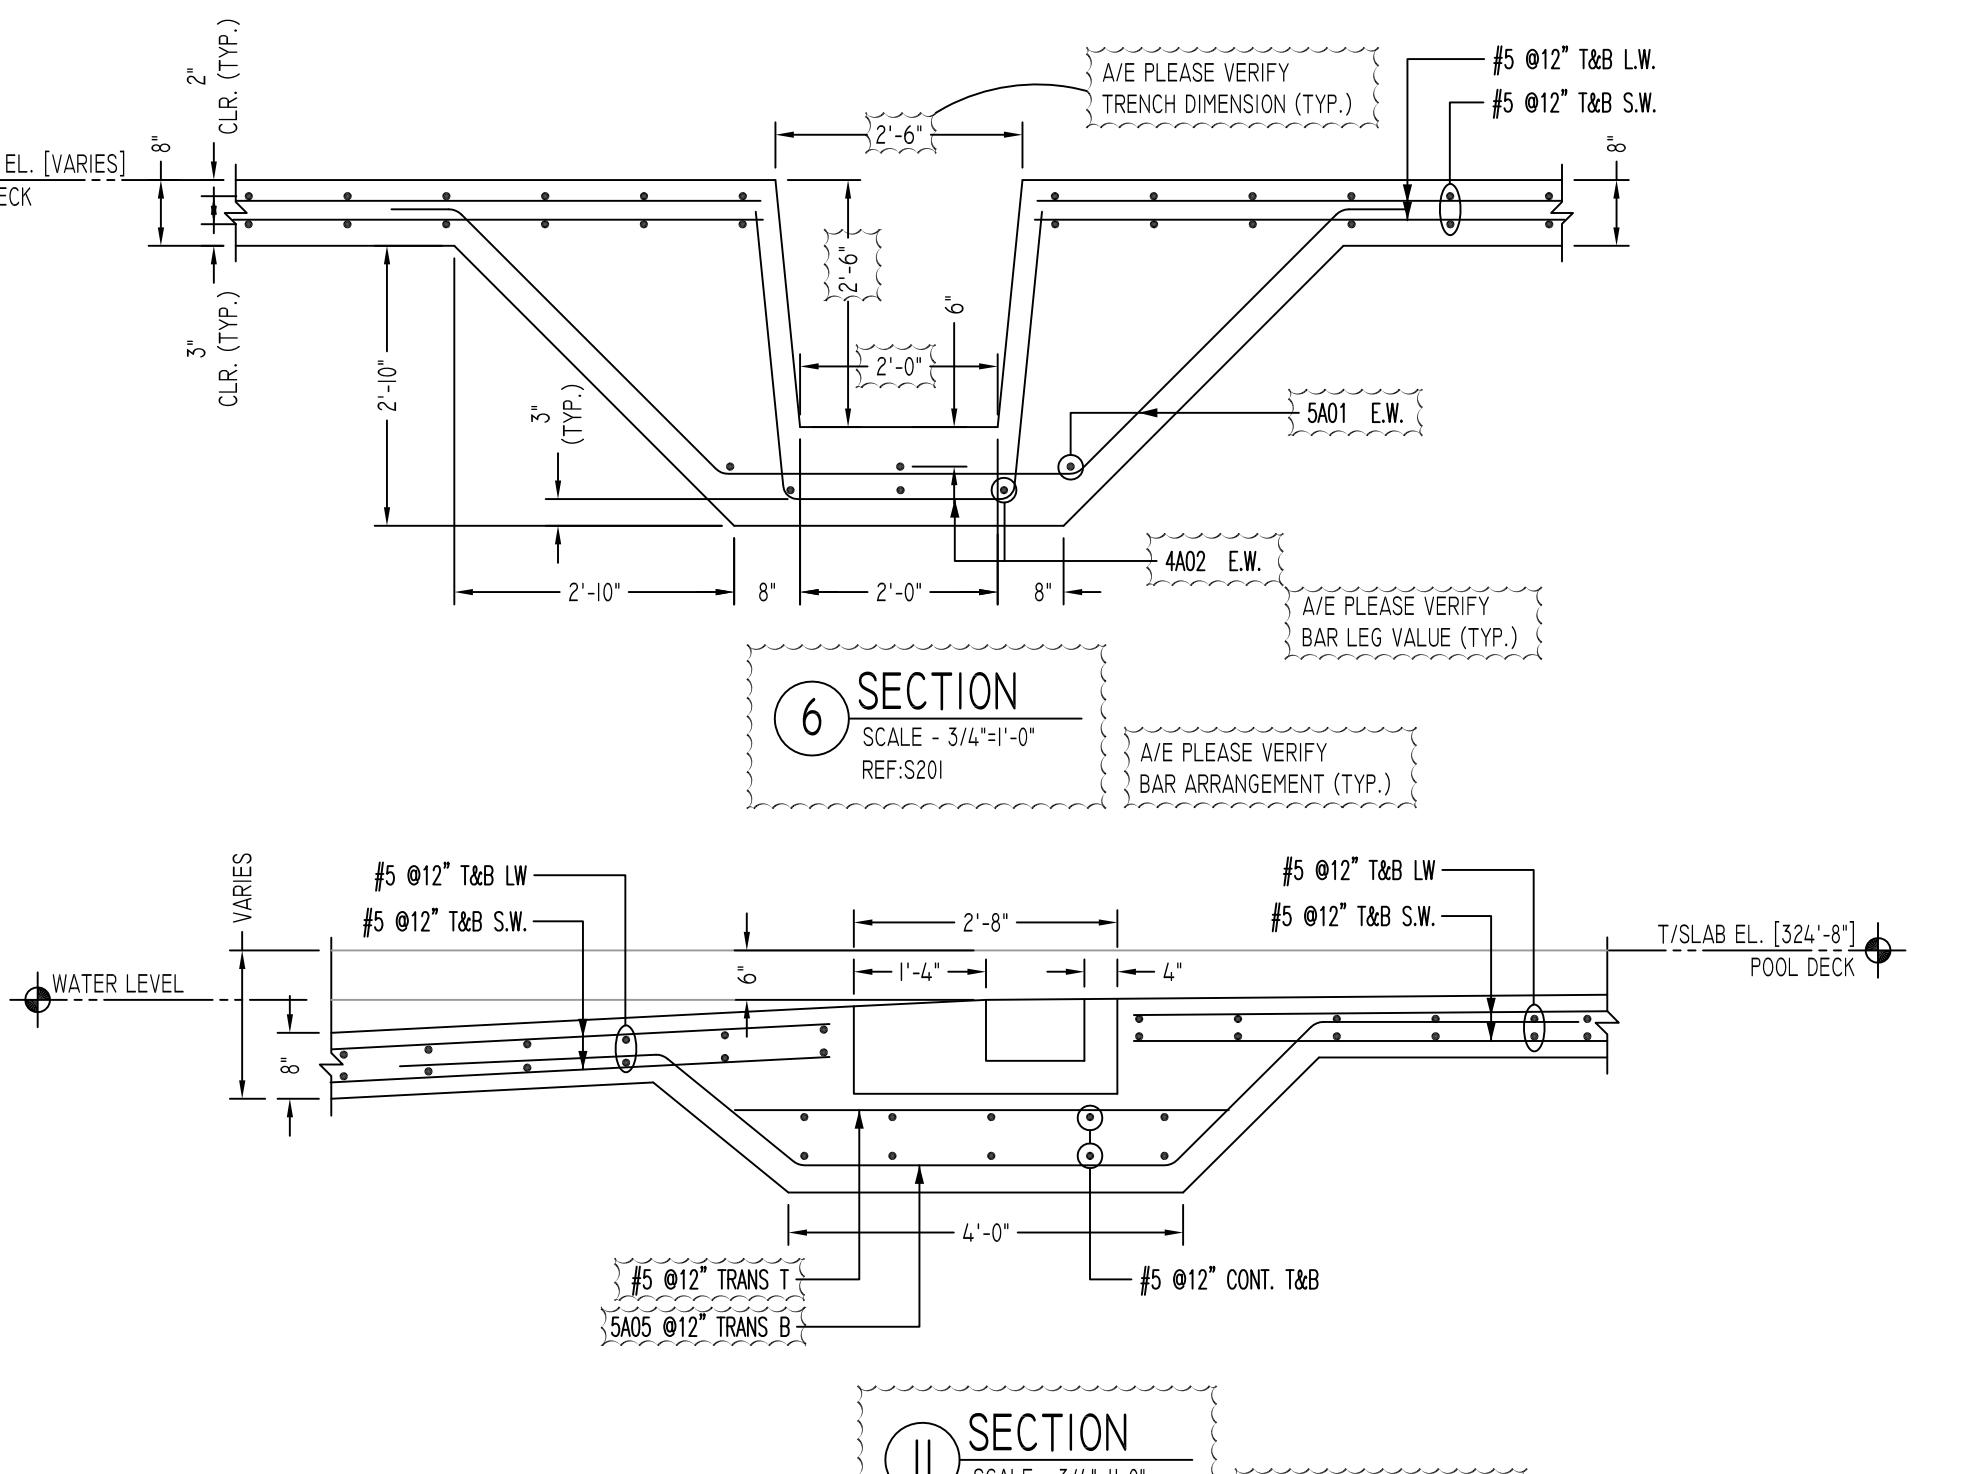ng  on Joint ANCE te Masonry Unit nous  n ment ay y ar ar ized	<h2 style="text-align: center;"><u>NOTICE</u></h2> <p>Shortages, improper fabrication or claims for any other reason must be reported to this company within a period of 15 days of delivery. This company reserves the right to field inspect prior to replacement or reconditioning of nonconforming material, and will not honor charges for work done in the field without specific authorization from this company.</p> <p style="text-align: center;">REINFORCING STEEL PLACING DRAWINGS ONLY USE IN CONJUNCTION WITH CONTRACT DRAWINGS &amp; SPECIFICATIONS. ELEVATIONS &amp; DIMENSIONS SHOWN ON THIS DRAWING ARE FOR DETAILING PURPOSES ONLY AND SHOULD NOT BE USED FOR CONSTRUCTION UNLESS VERIFIED BY ENGINEER OR CONTRACTOR.</p>
---	--


PROJECT	PAGE PARK POOL RENOVATION		
LOCATION	BRISTOL, CT 06010		
ARCHITECT	TLB ARCHITECTURE, LLC.		
ENGINEER	GNCB CONSULTING ENGINEERING, P.C.		
CUSTOMER	SAN MAT CONSTRUCTION		
AWN BY:	DATE:	REVIEWED BY:	JOB NO.
MRS	10/14/19	T/L	19129
DRAWING TITLE:	POOL BOTTOM MAT SLAB		DRAWING NO.:
			R1

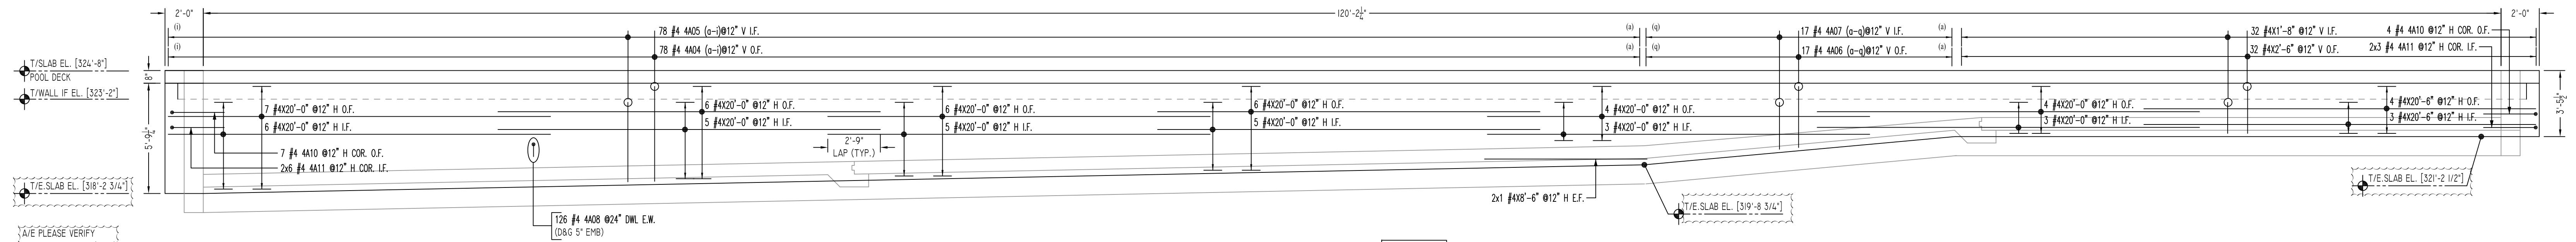


IA ELEVATION  
1'-0" THK. WALL  
SCALE - 1/4"=1'-0"  
REF.SI01, S301 & S302

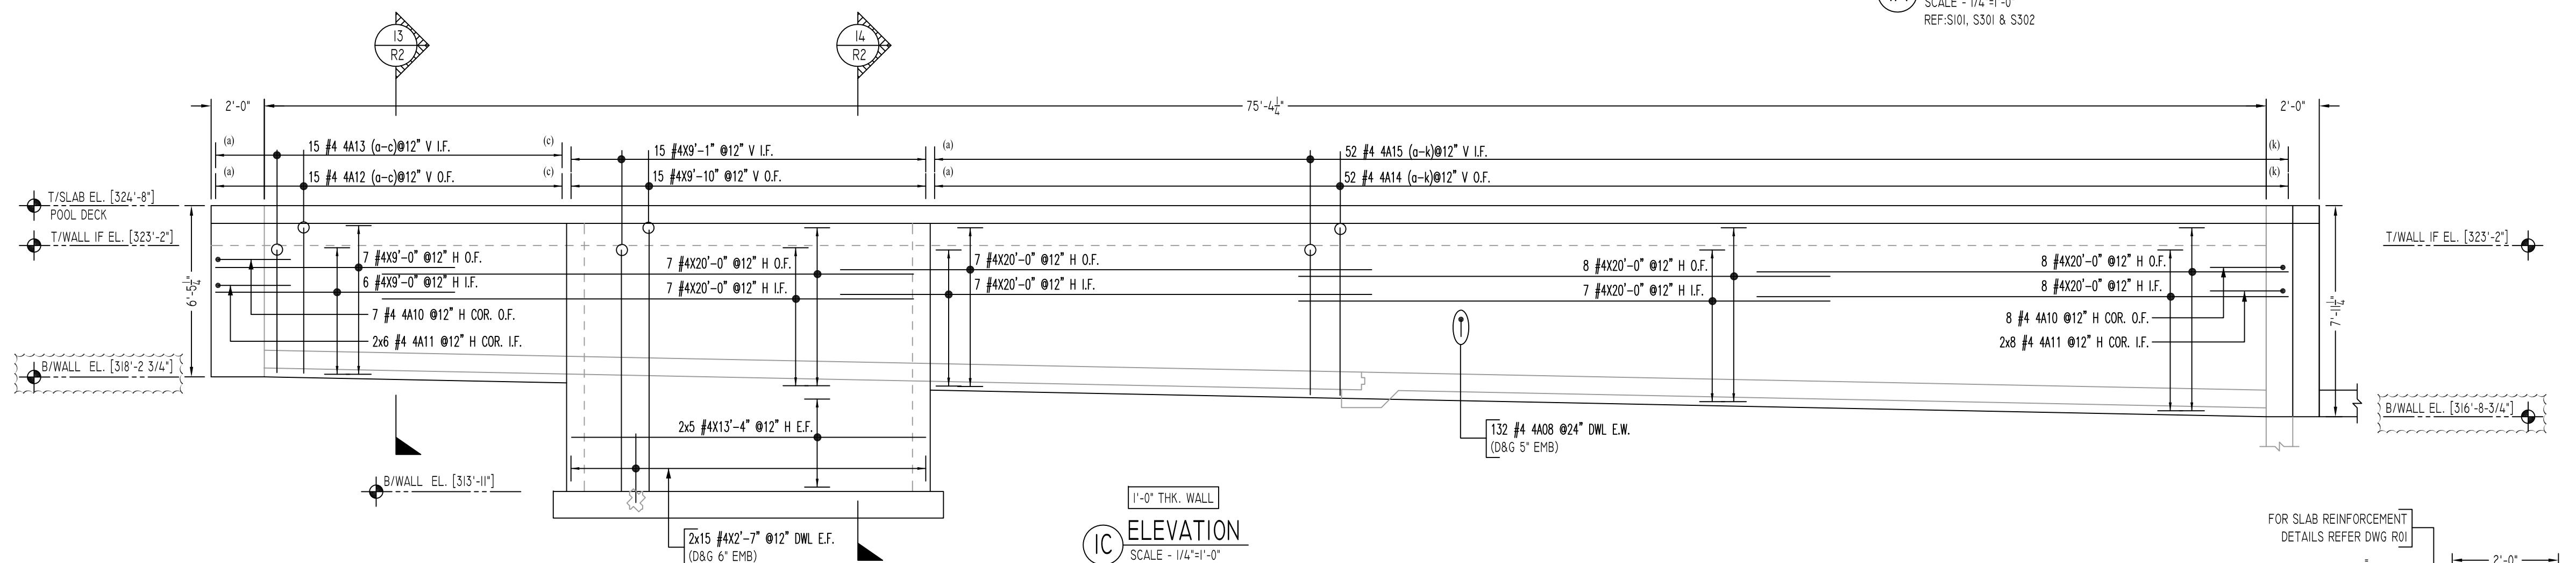


IC ELEVATION  
1'-0" THK. WALL  
SCALE - 1/4"=1'-0"  
REF.SI01, S301 & S302

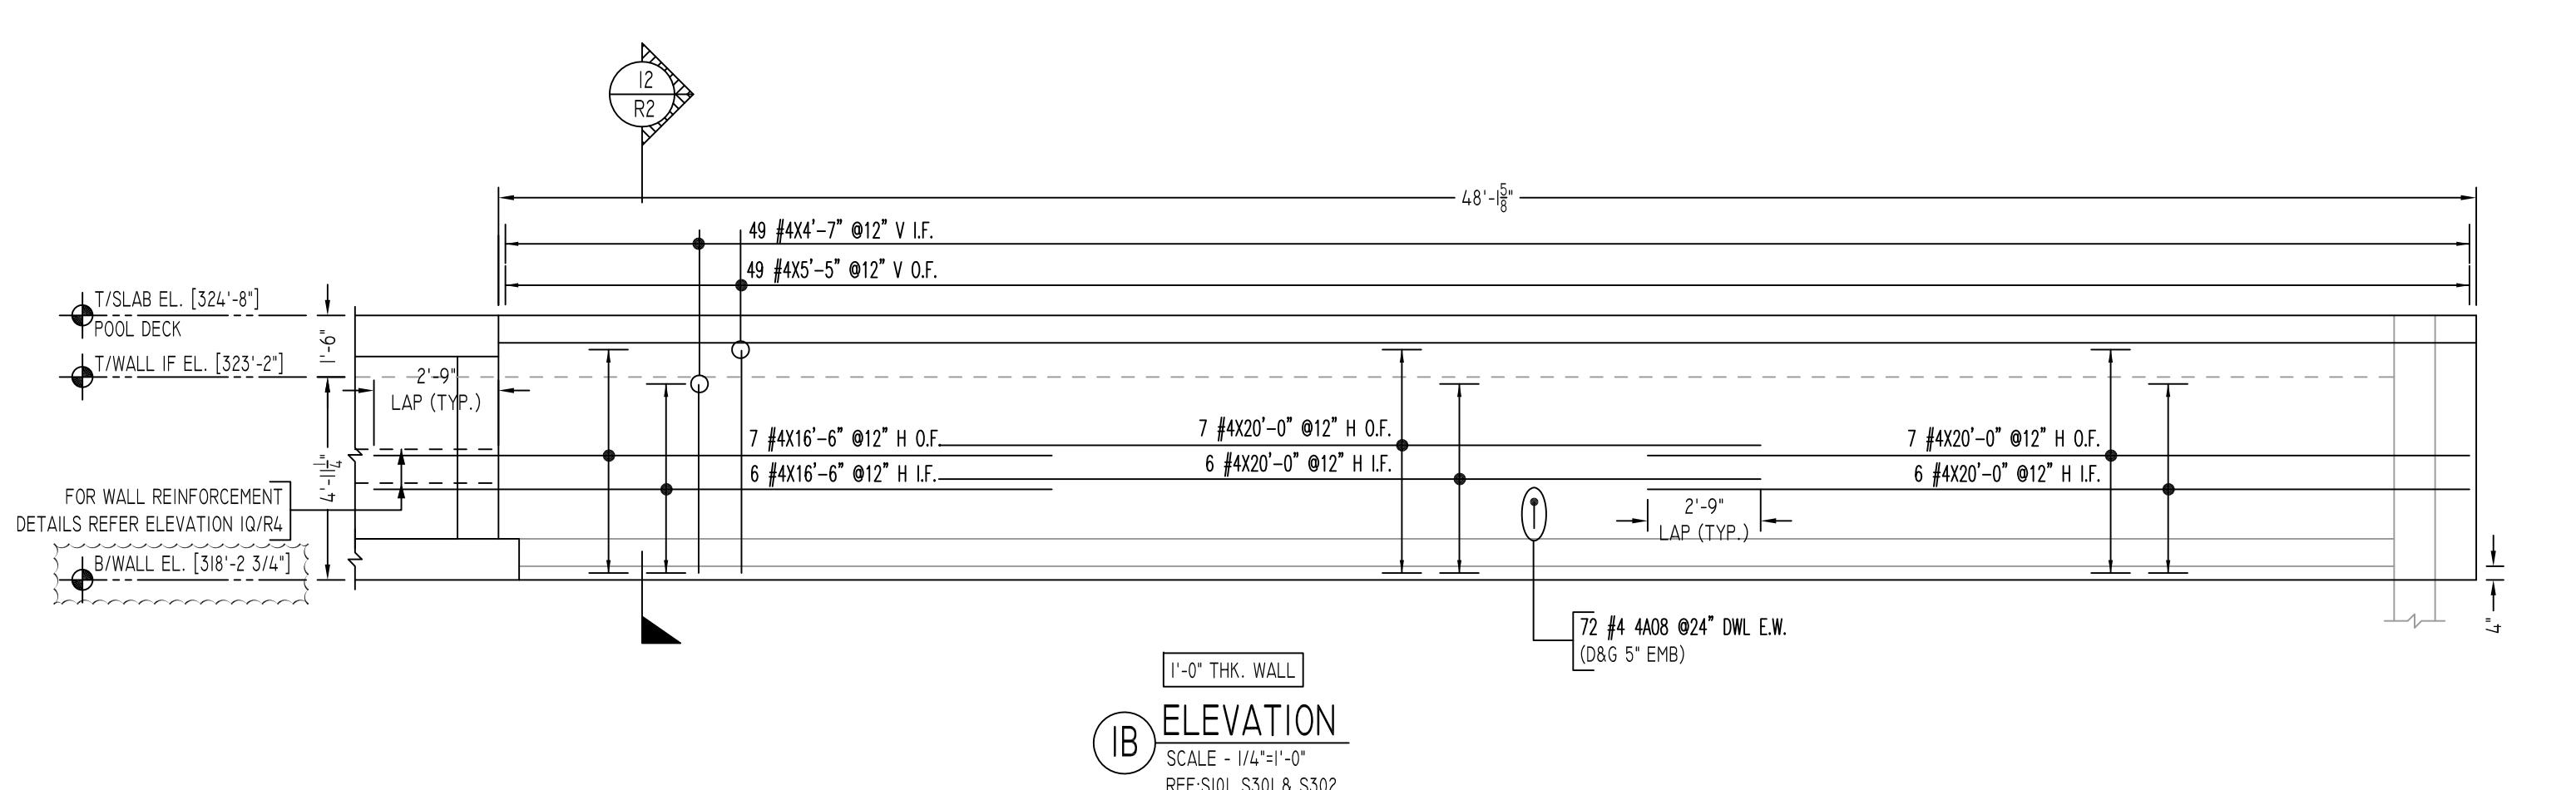


IB ELEVATION  
1'-0" THK. WALL  
SCALE - 1/4"=1'-0"  
REF.SI01, S301 & S302

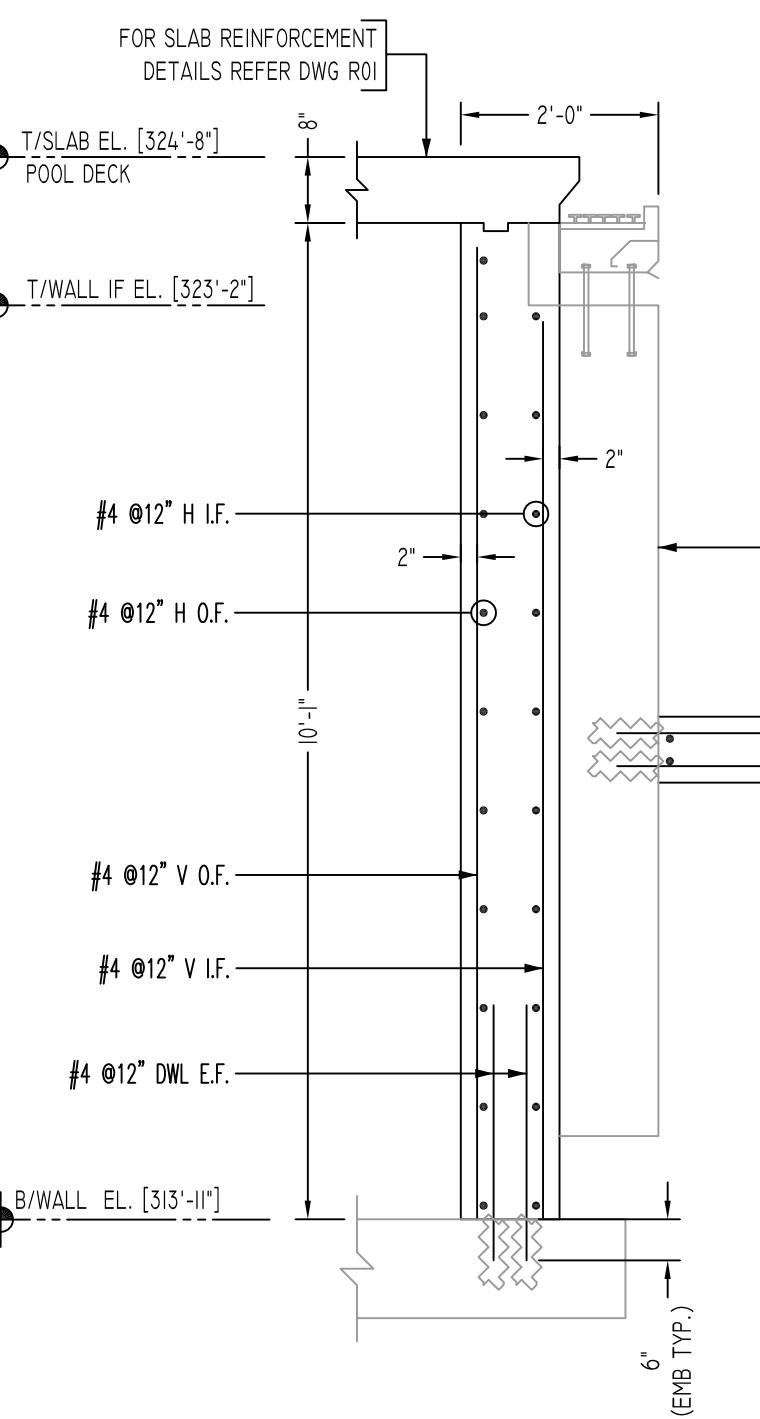

12 SECTION  
SCALE - 3/4"=1'-0"  
REF.3/S-301

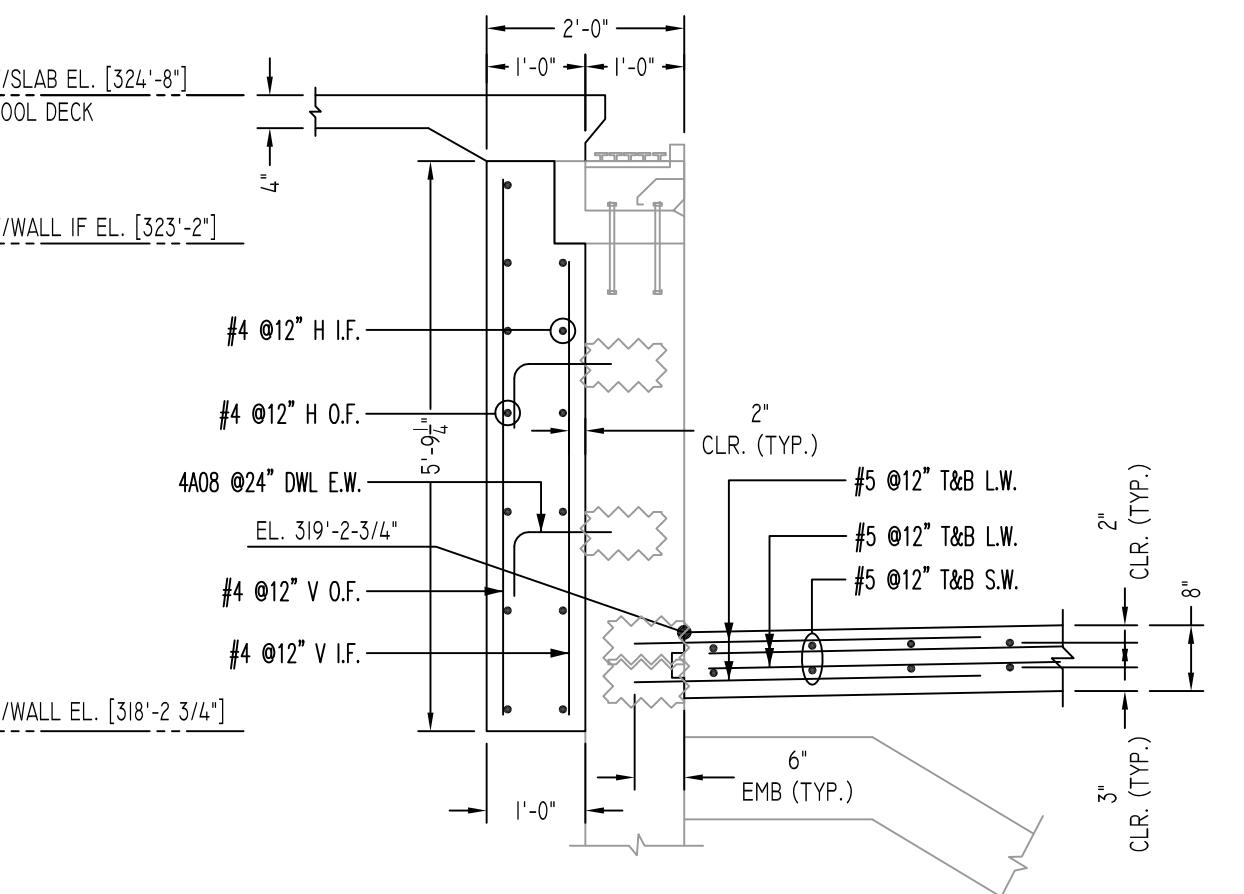


12 SECTION  
SCALE - 3/4"=1'-0"  
REF.3/S-301

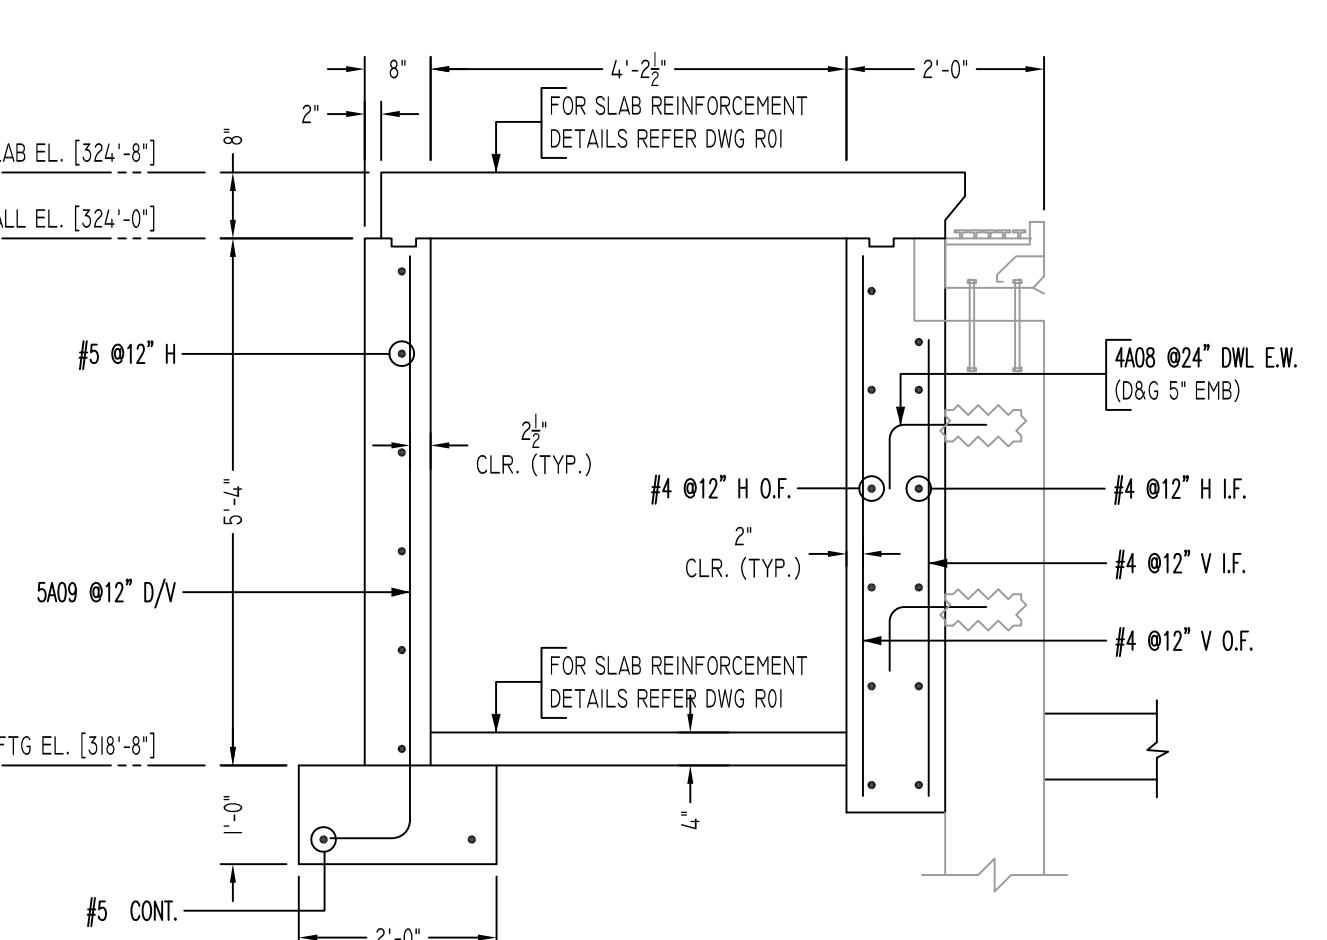


13 SECTION  
SCALE - 3/4"=1'-0"  
REF.3/S-301

BENDING DETAILS.																				
Bar Mark	Qty	Total length	Type	'A'	'B'	'C'	'D'	'E'	'F'	'G'	'H'	'I'	'J'	'K'	'L'	'M'	'N'	'O'	'P'	'R'
VARES TO																				
4A04a	9 #4	3'11"																		
VARES TO																				
4A05i	6 #4	4'7"																		
4A06a	1 #4	2'6"																		
VARES TO																				
4A06q	1 #4	3'11"																		
4A07a	1 #4	1'8"																		
VARES TO																				
4A07q	1 #4	3'11"																		
VARES TO																				
4A08	330 #4	18'2"																		
4A10	26 #4	5'9"																		
4A11	46 #4	35'2"																		
4A12a	6 #4	5'4"																		
VARES TO																				
4A12x	3 #4	5'7"																		
4A13a	6 #4	4'6"																		
VARES TO																				
4A13x	3 #4	4'9"																		
VARES TO																				
4A14a	5 #4	5'11"																		
VARES TO																				
4A14k	2 #4	6'11"																		
VARES TO																				
4A15k	2 #4	6'1"																		
VARES TO																				


<table border="1

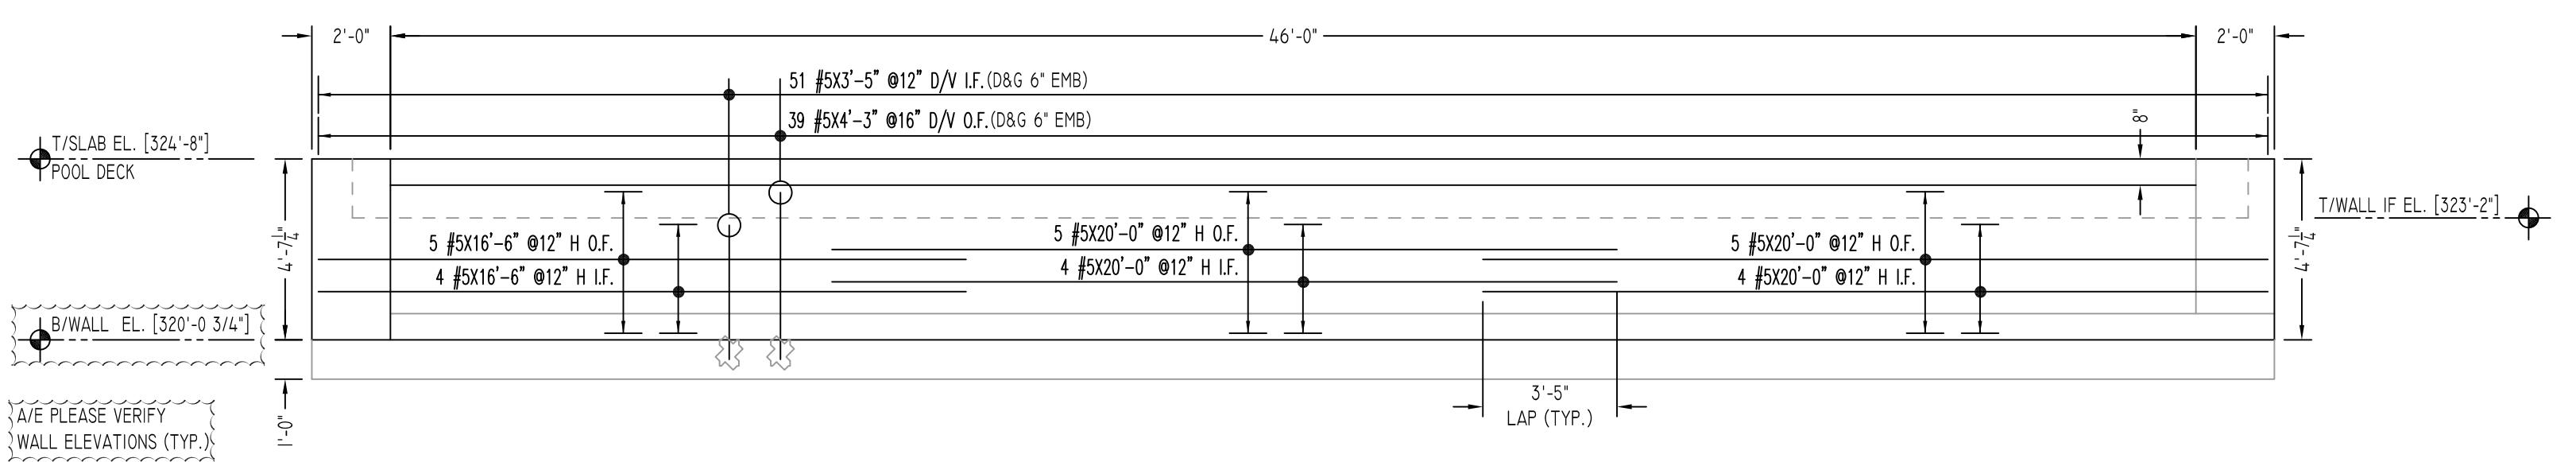


**ELEVATION**  
ID  
SCALE - 1/4"-1'-0"  
REF:S101, S301 & S302

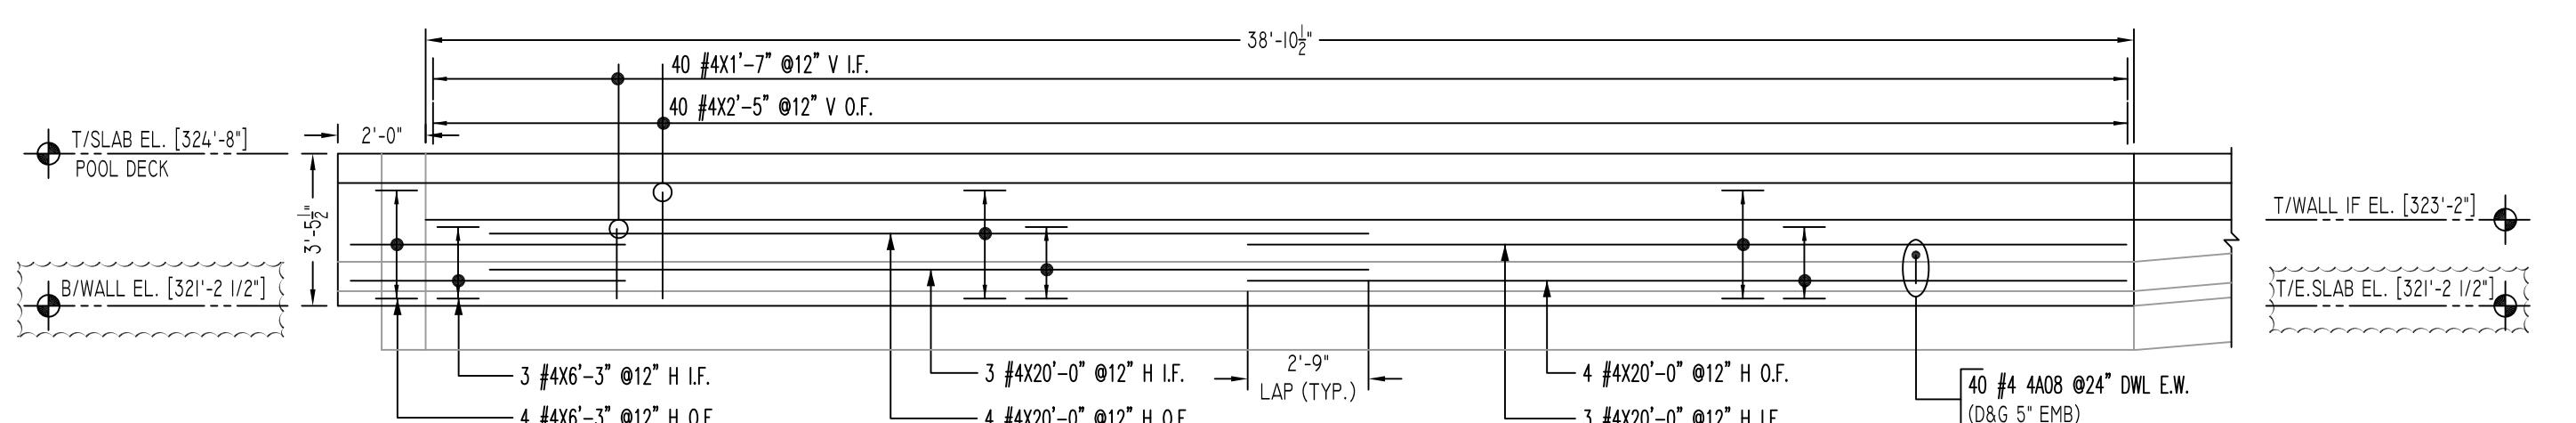


**ELEVATION**  
IG  
SCALE - 1/4"-1'-0"  
REF:S101, S301 & S302

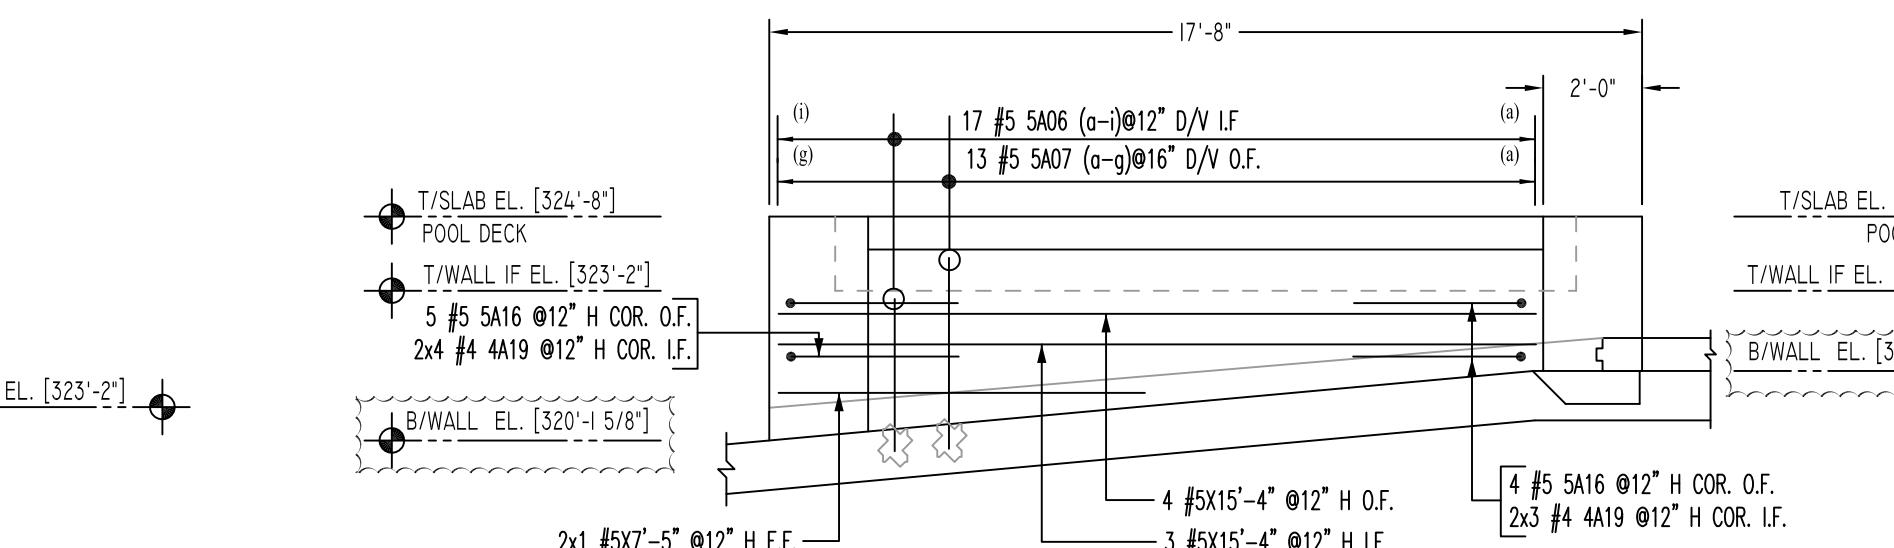


**ELEVATION**  
IE  
SCALE - 1/4"-1'-0"  
REF:S101, S301 & S302

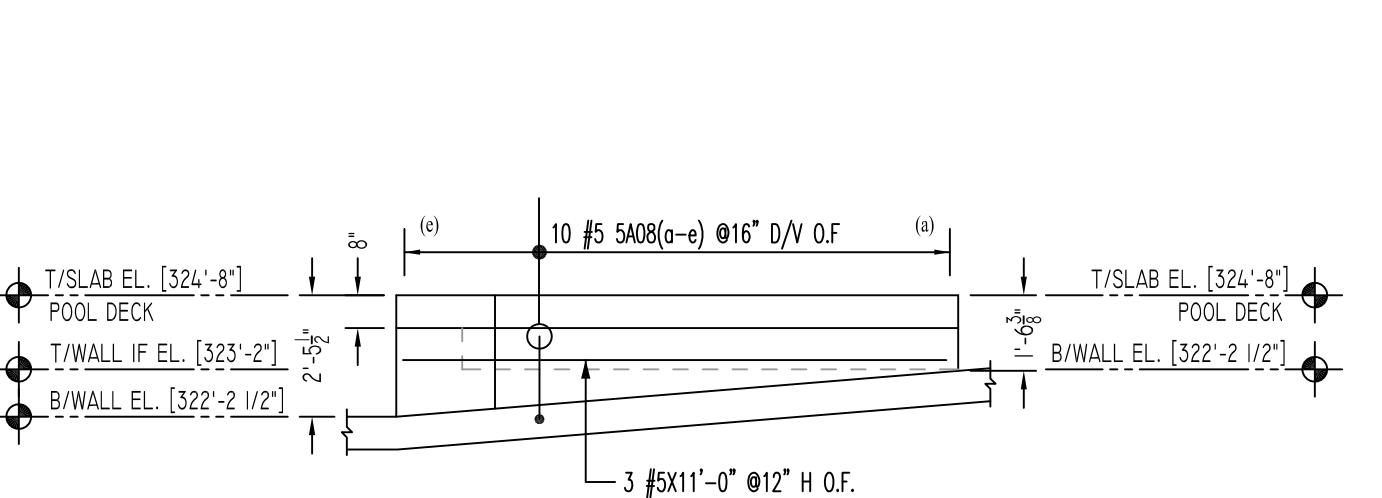


**ELEVATION**  
IF  
SCALE - 1/4"-1'-0"  
REF:S101, S301 & S302

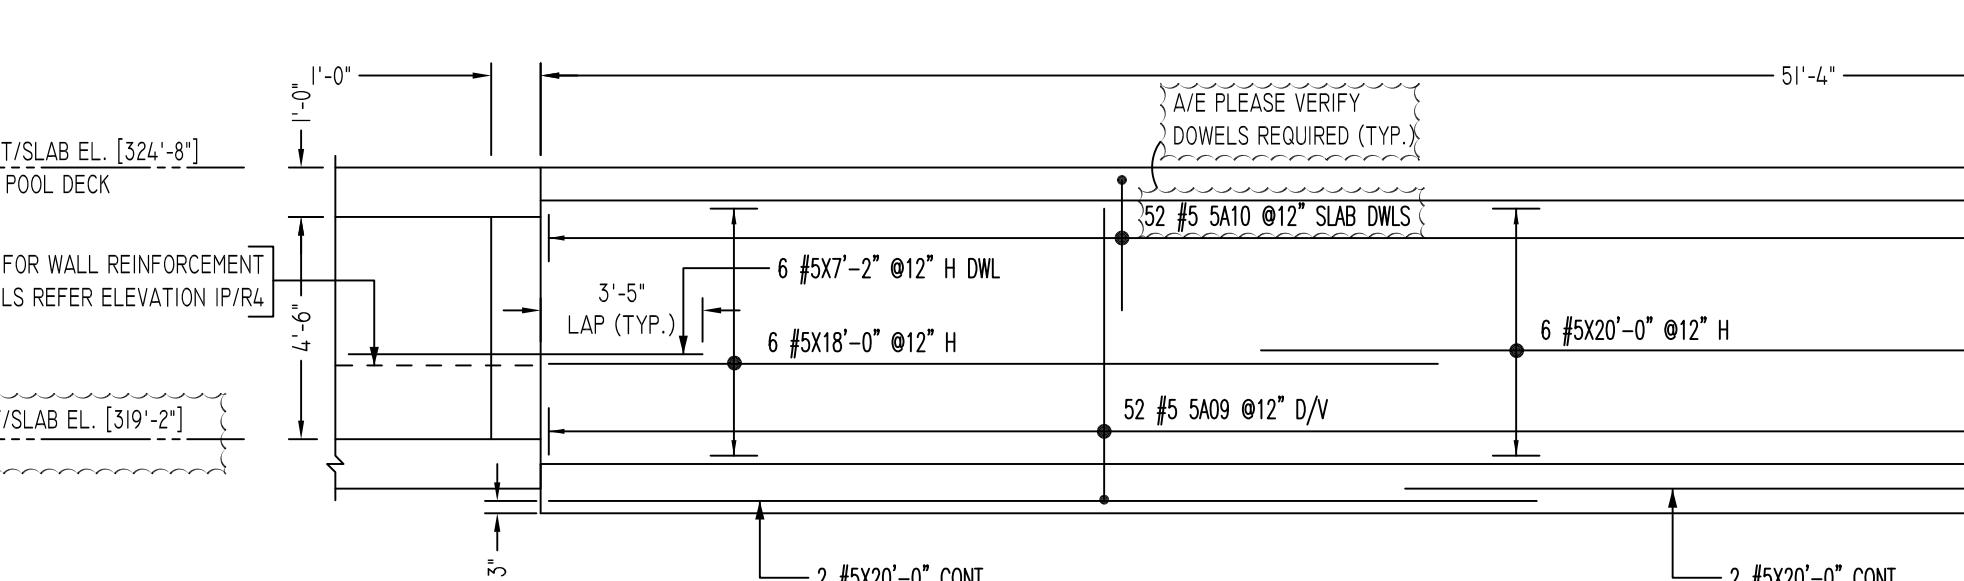


**ELEVATION**  
IH  
SCALE - 1/4"-1'-0"  
REF:S101, S301 & S302

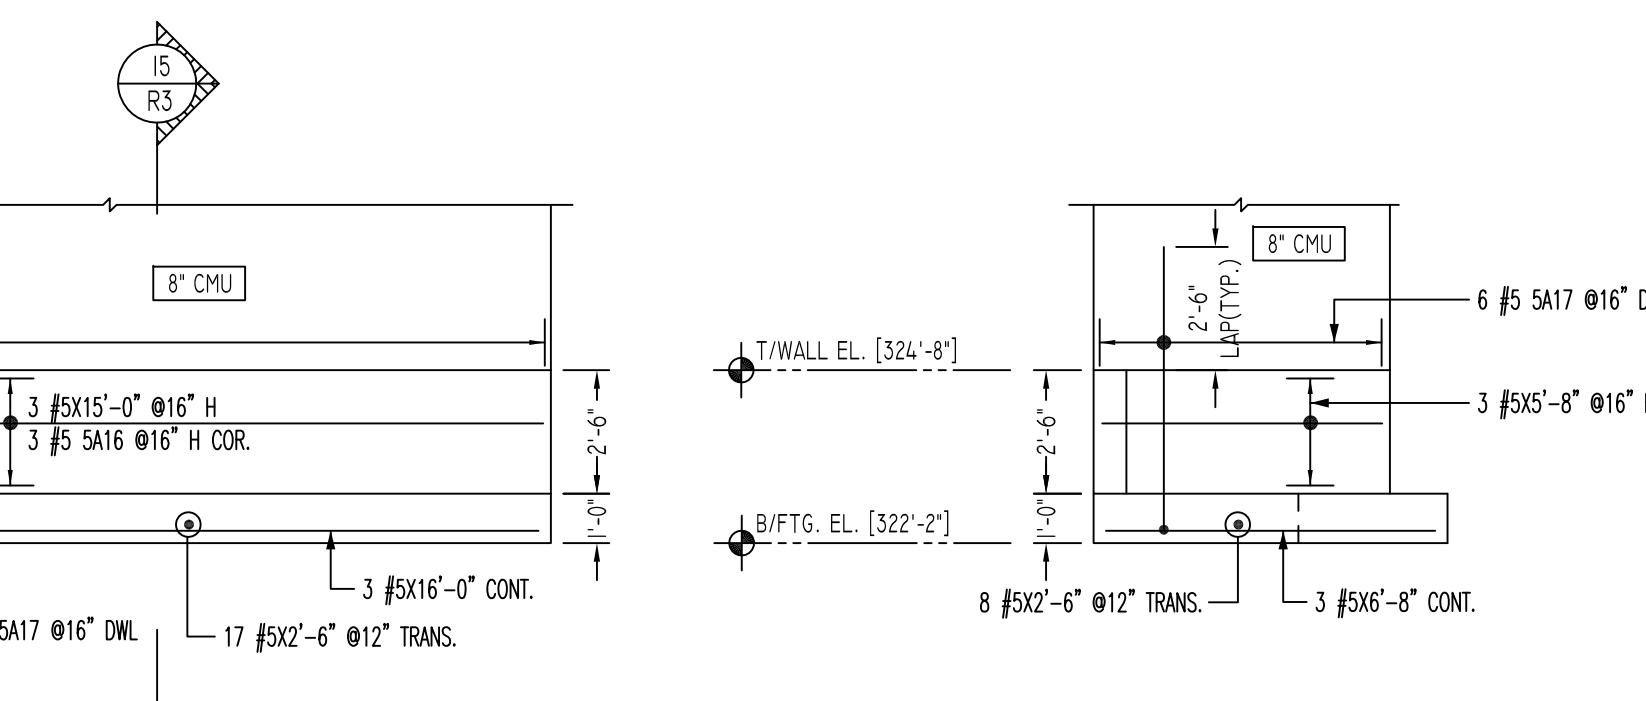

**ELEVATION**  
IL  
SCALE - 1/4"-1'-0"  
REF:S101, S301 & S302

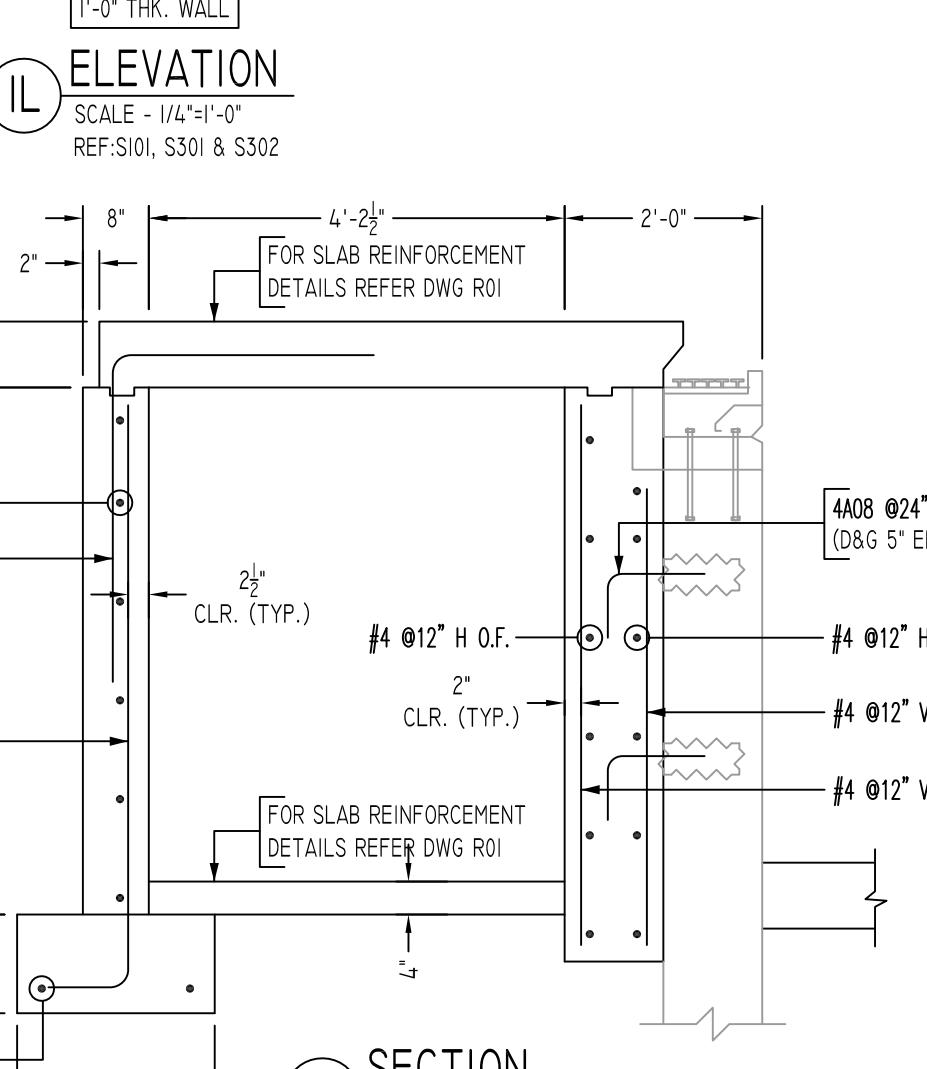


**ELEVATION**  
IM  
SCALE - 1/4"-1'-0"  
REF:S101, S301 & S302

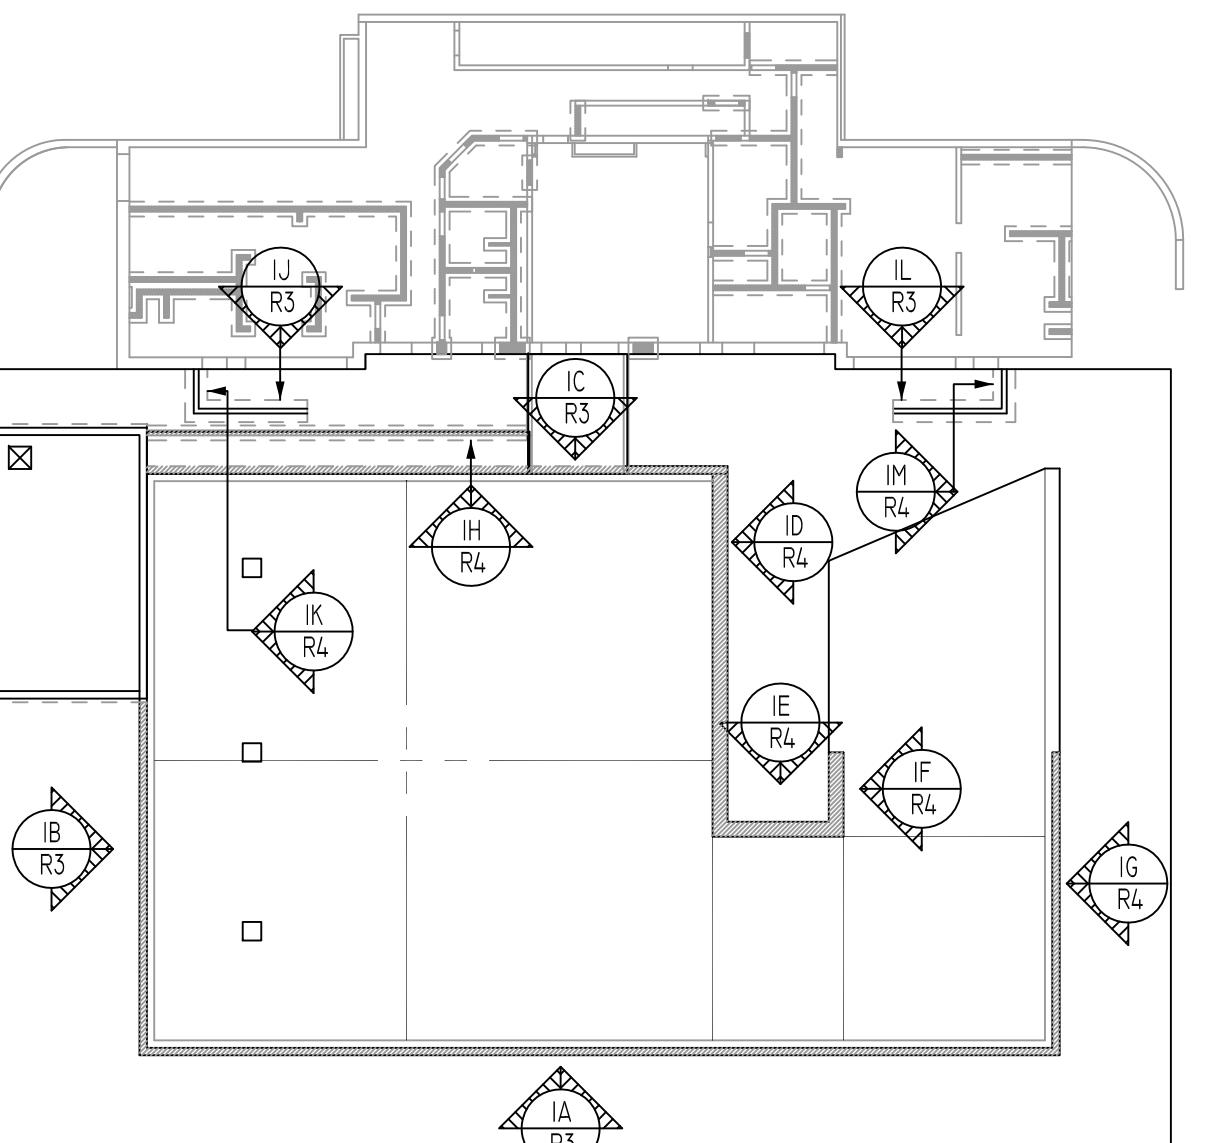

**KEY PLAN**  
SCALE - N.T.S.  
REF:S101

Release Code: R3										BENDING DETAILS.									
Bar Mark	Qty	Size	Total length	Type	'A'	'B'	'C'	'D'	'E'	'F'	'G'	'H'	'I'	'J'	'K'	'L'	'R'		
A408	40	#4	19' <sup>1</sup> / <sub>2</sub>	8"	10"														
A419	14	#4	4' <sup>1</sup> / <sub>2</sub>	8"	35"														
S406a	2	#5	11'			111"													
VARIES TO																			
S406i	1	#5	34"			34"													
S407a	2	#5	29"			29"													
VARIES TO																			
S407g	1	#5	42"			42"													
S408a	2	#5	110 <sup>1</sup> / <sub>2</sub>		10"	10 <sup>1</sup> / <sub>2</sub>													
VARIES TO																			
S408b	2	#5	29"		10"	10"													
S409	52	#5	69 <sup>1</sup> / <sub>2</sub>		10"	51"													
S410	52	#5	69 <sup>1</sup> / <sub>2</sub>		28"	34"													
S411	6	#5	54 <sup>1</sup> / <sub>2</sub>		28"	28"													
S416	16	#5	69 <sup>1</sup> / <sub>2</sub>		35"	35"													
S417	19	#5	67 <sup>1</sup> / <sub>2</sub>		10"	59"													
S418	6	#5	81 <sup>1</sup> / <sub>2</sub>		10"	73"													
S419	3	#5	76 <sup>1</sup> / <sub>2</sub>		46 <sup>1</sup> / <sub>2</sub>	211 <sup>1</sup> / <sub>2</sub>													
S420	2	#5	71 <sup>1</sup> / <sub>2</sub>		10"	63"													

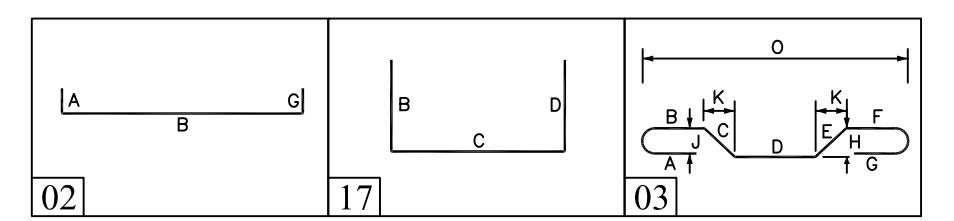

ALL BARS IN THIS DRAWING  
ASTM A615 GRADE 60  
BLACK UNCOATED

LAP SCHEDULE	
WALLS	
SIZE	
VERT. BARS	HORIZ. BARS
#3	20"
#4	25"
#5	32"
#6	38"
#7	42"
#8	46"
#9	50"
#10	55"
#11	63"
#12	71"
#13	78"
#14	88"
#15	114"

**SECTION**  
13  
SCALE - 3/4"-1'-0"  
REF:3/S-301

**SECTION**  
15  
SCALE - 3/4"-1'-0"  
REF:3/S-301


Abbreviations:  
IF=Inside Face  
OF=Outside Face  
E.F.=End Face  
DWL=Dowel  
BTW=Between  
CP=Construction Joint  
CLR=Clearance  
CMU=Concrete Masonry Unit  
CONT=Continuous  
C.B.=Corner Bar  
SDWL=Slab Dowel  
EW=Each Way  
BOT=Bottom  
T=Top  
MDWL=Masonry Dowel  
B.B.=Bond Beam  
ALT=Alternate  
Approx=Approximate

OPNG=Opening  
BAL=Balance  
BTW=Between  
CP=Construction Joint  
CLR=Clearance  
CMU=Concrete Masonry Unit  
CONT=Continuous  
EA=Each  
Elev.=Elevation  
EMB=Embedment  
SW=Short Way  
LW=Long Way  
(BL)=Black Bar  
(EP)=Epoxy Bar  
(GA)=Galvanized

Shortages, improper fabrication or claims for any other reason must be reported to this company within a period of 15 days of delivery. This company reserves the right to field inspect prior to replacement or reconditioning of nonconforming material and will not honor charges for work done in the field without specific authorization from this company.

REINFORCING STEEL PLACING DRAWINGS ONLY USE IN CONJUNCTION WITH CONTRACT DRAWINGS & SPECIFICATIONS. ELEVATIONS & DIMENSIONS SHOWN ON THIS DRAWING ARE FOR DETAILING PURPOSES ONLY AND SHOULD NOT BE USED FOR CONSTRUCTION UNLESS VERIFIED BY ENGINEER OR CONTRACTOR.

PROJECT	PAGE PARK POOL RENOVATION
LOCATION	BRISTOL, CT 06010
ARCHITECT	TLB ARCHITECTURE, LLC.
ENGINEER	GNCB CONSULTING ENGINEERING, P.C.
CUSTOMER	SAN MAT CONSTRUCTION
DRAWN BY:	MRS
DATE:	10/14/19
REVIEWED BY:	T/L
JOB NO.:	19129
DRAWING TITLE:	POOL WALL REINFORCEMENT DETAILS
DRAWING NO.:	R3

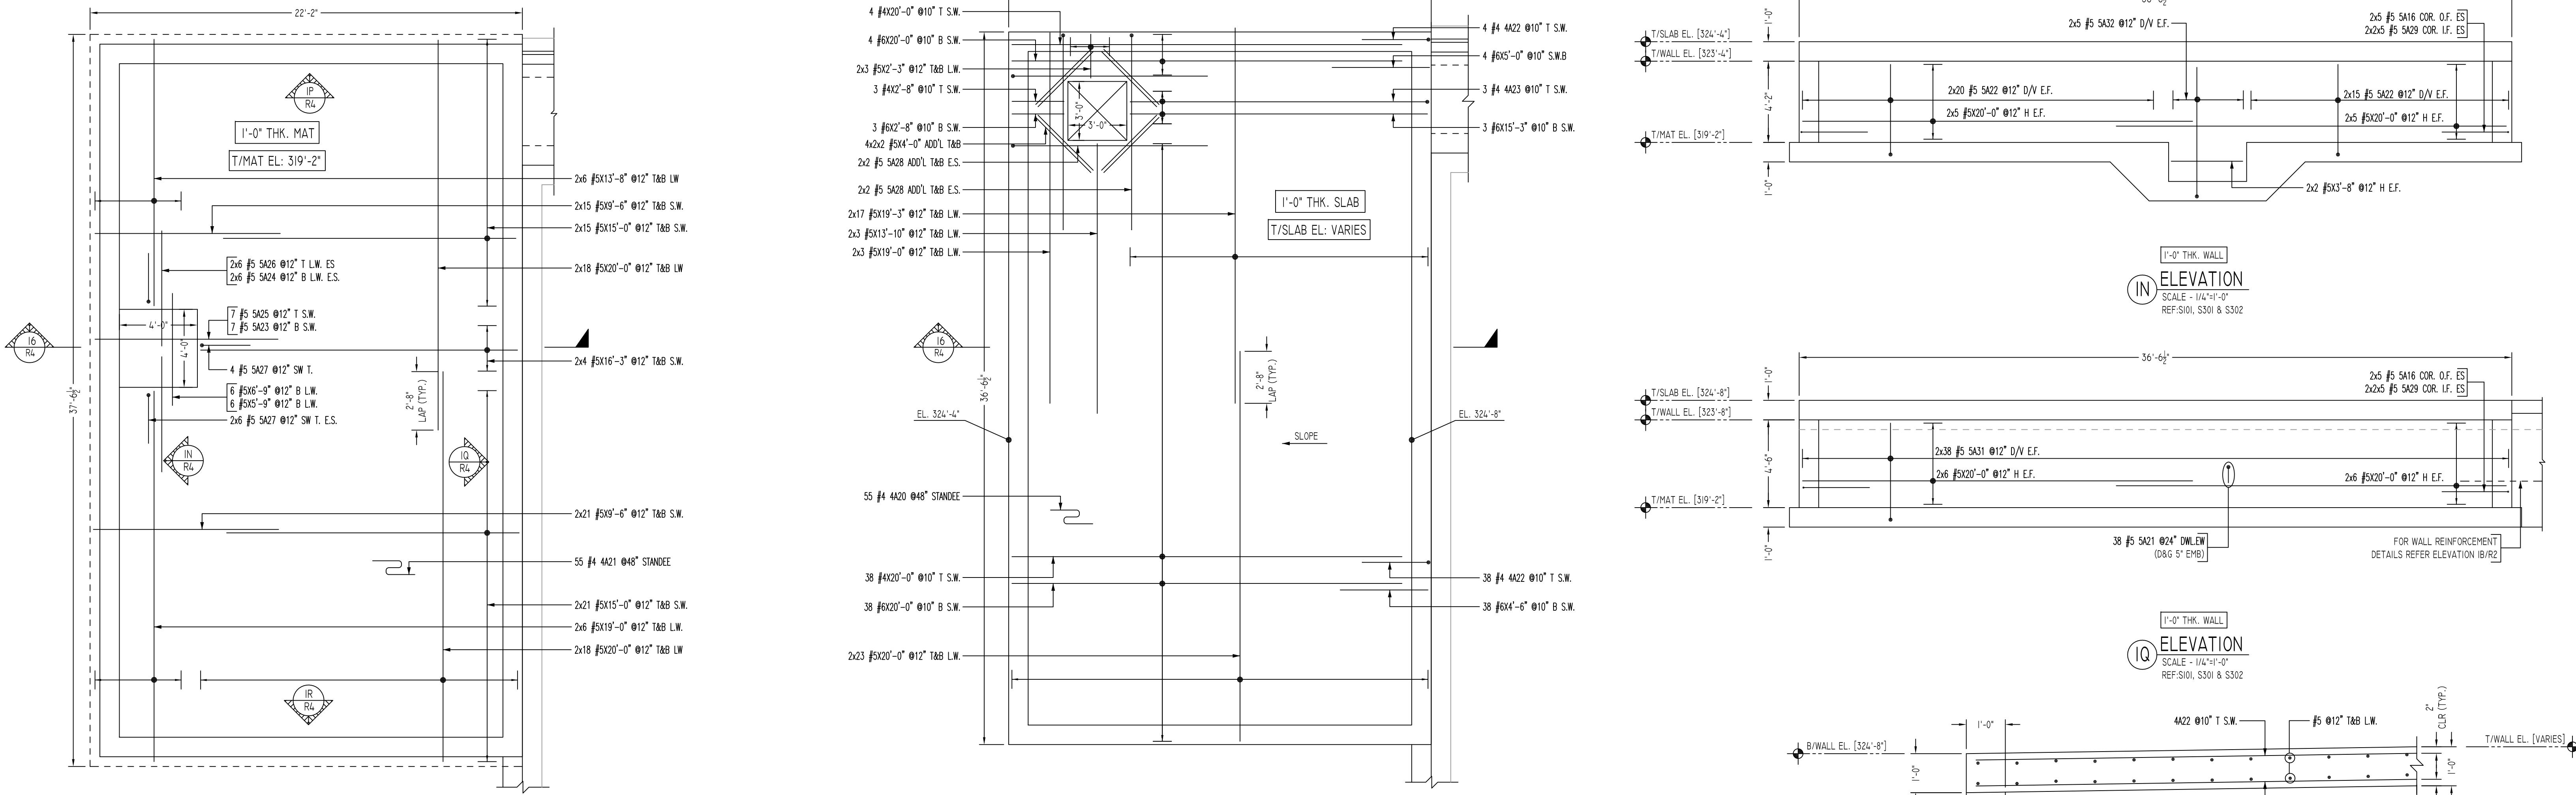

(BOTTOM MAT SLAB)  
SURGE TANK REINFORCEMENT DETAILS  
DETAIL - A

SCALE - 1/4"=1'-0"  
REF:SI02

(TOP SLAB)  
SURGE TANK REINFORCEMENT DETAILS  
DETAIL - A


SCALE - 1/4"=1'-0"  
REF:SI02

IN ELEVATION  
SCALE - 1/4"=1'-0"  
REF:SI01, S301 & S302

IQ ELEVATION  
SCALE - 1/4"=1'-0"  
REF:SI01, S301 & S302

SECTION  
SCALE - 3/4"=1'-0"  
REF:3/S-301

BENDING DETAILS.																		
Bar Mark	Qty	Size	Total length	Type	'A'	'B'	'C'	'D'	'E'	'F'	'G'	'H'	'I'	'J'	'K'	'L'	'M'	'R'
A420	55	#4	6'10 1/2"	25		16"	6"	10"	6"	16"		6"		3"				
A421	55	#4	5'0 1/2"	25		16"	7"	10"	7"	16"		4 1/2"		2"				
A422	42	#4	3'11 1/2"	1		6"	35"											
A423	3	#4	15'9 1/2"	1		6"	153"											
S416	20	#5	6'10 1/2"	17		35"	35"											
S421	38	#5	1'10 1/2"	2		10"	10"											
S422	70	#5	5'9 1/2"	2		10"	47 1/2"											
S423	7	#5	10'5 1/2"	3		10"	35 1/2"	62"			26"		25"	94 1/2"				
S424	12	#5	6'11 1/2"	3		10"	35 1/2"	28"			26"		25"	51"				
S425	7	#5	7'6 1/2"	3		68"	10"				7 1/2"		7"	73"				
S426	12	#5	3'6 1/2"	3		28"	10"			7 1/2"		7"	33"					
S427	16	#5	5'2 1/2"	17		26"	28"											
S428	8	#5	10'7 1/2"	1		7"	100"							5"				
S429	40	#5	4'3 1/2"	2		10"	35"											
S430a	4	#5	5'5 1/2"	2		10"	47"											
VARIES TO																		
S430w	4	#5	5'9 1/2"	2		10"	41 1/2"											
S431	76	#5	5'9 1/2"	2		10"	41 1/2"											
S432	10	#5	7'5 1/2"	2		10"	67 1/2"											

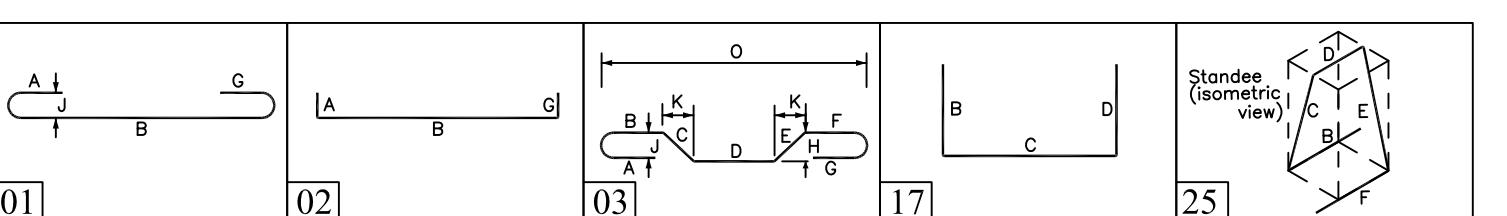


#### LAP SCHEDULE

SIZE	SLAB / MAT	
	12" THK LESS	12" THK GREATER
#3	ALL	BOT
#4	20"	20"
#5	25"	25"
#6	32"	41"
#7	38"	49"
#8	82"	106"
#9	94"	121"
#10	109"	137"
#11	119"	154"
	132"	171"

ALL BARS IN THIS DRAWING  
ASTM A615 GRADE 60  
BLACK UNCOATED

#### LAP SCHEDULE

SIZE	WALLS	
	VERT.BARS	HORIZ.BARS
#3	20"	25"
#4	25"	33"
#5	32"	41"
#6	38"	49"
#7	82"	106"
#8	94"	121"
#9	109"	137"
#10	119"	154"
#11	132"	171"

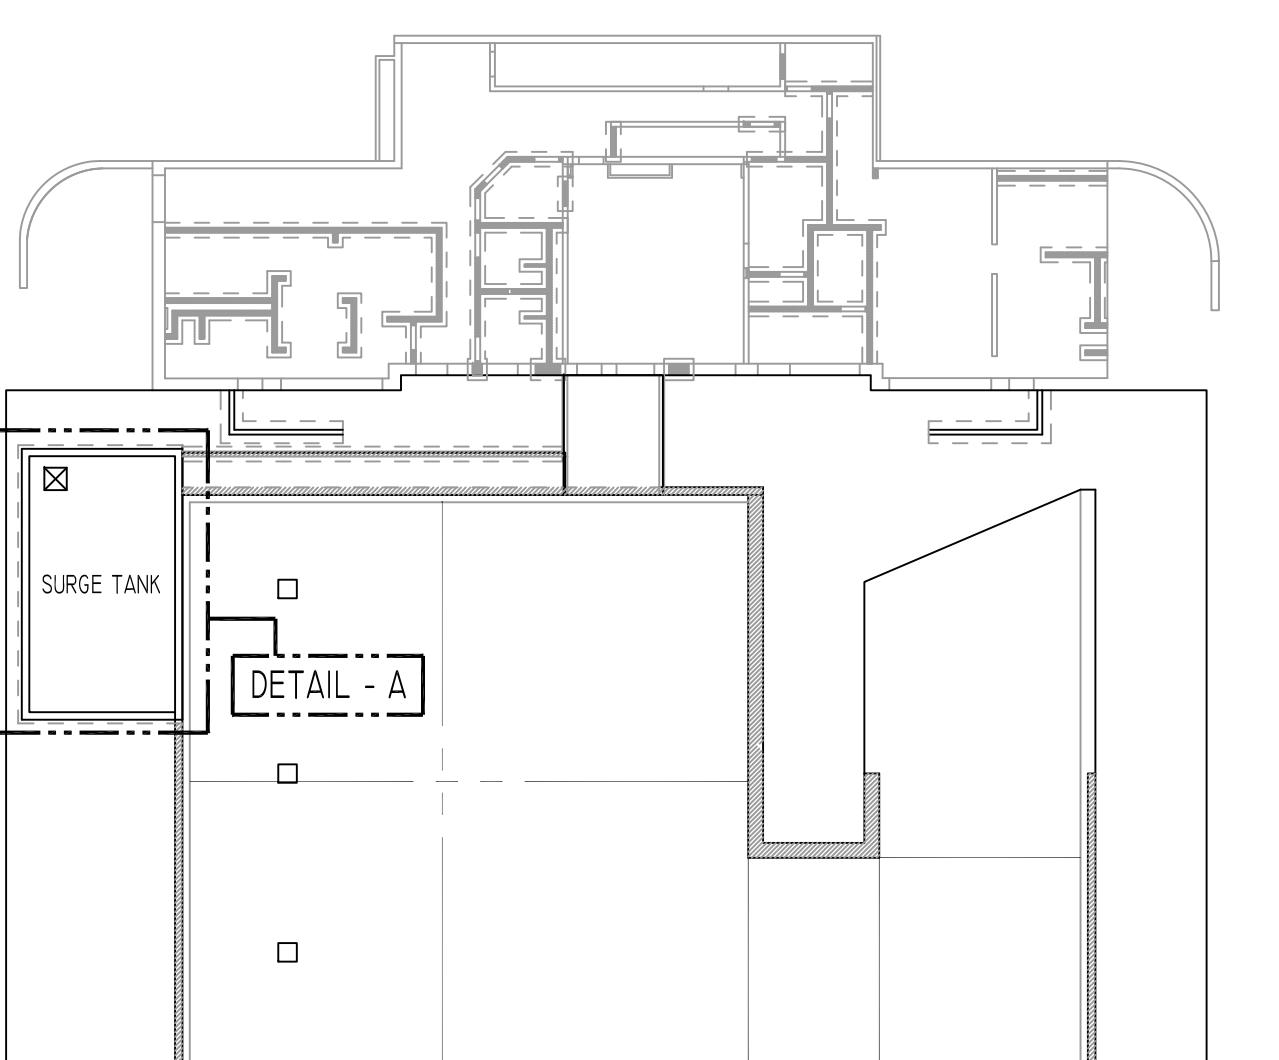

KEY PLAN  
SCALE - N.T.S.  
REF:SI01

Abbreviations:  
IF=Inside Face  
OF=Outside Face  
EF=Each Face  
DWL=Dowel  
V=Vertical  
H=Horizontal  
CB=Corner Bar  
SDWL=Sub-Dowel  
EW=Each Way  
BOT=Bottom  
T=Top  
MDWL=Masonry Dowel  
B.B.=Bond Beam  
ALT.=Alternate  
Approx.=Approximate

OPNG=Opening  
BAL=Balance  
BTW-Between  
CP=Construction Joint  
CLR=CLEARANCE  
CMU=Concrete Masonry Unit  
CONT=Continuous  
EA=Each  
Elev.=Elevation  
EMB=Embedment  
SW=Short Way  
LW=Long Way  
(BL)=Black Bar  
(EP)=Epoxy Bar  
(GA)=Galvanized

NOTICE  
Shortages, improper fabrication or claims for any other reason must be reported to this company within a period of 15 days of delivery. This company reserves the right to field inspect prior to replacement or reconditioning of nonconforming material and will not honor charges for work done in the field without specific authorization from this company.

REINFORCING STEEL PLACING DRAWINGS ONLY USE IN CONJUNCTION WITH CONTRACT DRAWINGS & SPECIFICATIONS. ELEVATIONS & DIMENSIONS SHOWN ON THIS DRAWING ARE FOR DETAILING PURPOSES ONLY AND SHOULD NOT BE USED FOR CONSTRUCTION UNLESS VERIFIED BY ENGINEER OR CONTRACTOR.

PROJECT PAGE PARK POOL RENOVATION  
LOCATION BRISTOL, CT 06010  
ARCHITECT TLB ARCHITECTURE, LLC.  
ENGINEER GNCB CONSULTING ENGINEERING, P.C.  
CUSTOMER SAN MAT CONSTRUCTION  
DRAWN BY: MRS DATE: 10/14/19 REVIEWED BY: T/L JOB NO.: 19129  
DRAWING TITLE: SURGE TANK REINFORCEMENT DETAILS DRAWING NO.: R4