


BENDING DETAILS.																
Bar Mark	Dly	Size	Total length	Type	'A'	'B'	'C'	'D'	'E'	'F'	'G'	'H'	'I'	'K'	'O'	'R'
D301	28	#3	58'11"		4"	13"	13"	13"	13"	4"	2 1/2"					
D502	3	#5	28'9 1/2"		20"	24 9/16"	20"									
D503	3	#5	24'10 1/2"		20"	20 10/16"	20"									
D504	3	#5	12'2 1/2"		20"	82"	20"									
D505	3	#5	3'8 1/2"		20"	278"	20"									
D701	16	#7	4'3 1/2"		12"	31"										

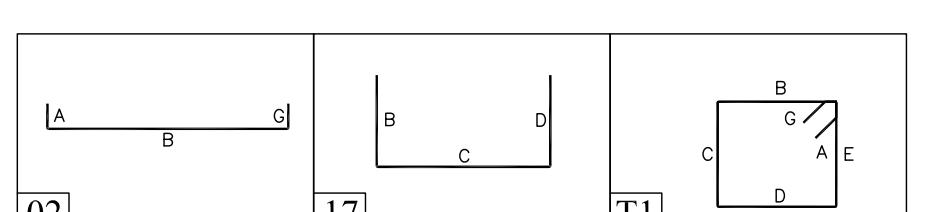

LAP SCHEDULE	
SIZE	36 X BD LAP
#4	18"
#5	23"
#6	27"
#7	32"

A/E PLEASE VERIFY LAP VALUE (TYP.)	
TYPICAL REINFORCING BAR CLEARANCE TABLE	
LOCATION	
FOOTINGS AGAINST EARTH	
COLUMNS AND PIERS (TIES, REINF.)	
WALLS INTERIOR FACE	
WALLS EXTERIOR FACE (#5 & SMALLER)	
WALLS INTERIOR FACE (#6 & LARGER)	
WALLS EXTERIOR FACE (#6 & LARGER)	


ALL BARS IN THIS DRAWING
ASTM A615 GRADE 60
BLACK UNCOATED

Abbreviations:
IF=Inside Face
O.F.=Outside Face
E.F.=Each Face
DWL=Dowel
V=Vertical
H=Horizontal
CB=Corner Bar
SDW=Shab Dowel
E.W.=Each Way
BBOT=Bottom
T=Top
MDWL=Masonry Dowel
B.B.=Bond Beam
ALT=Alternate
Approx=Approximate
OPNG=Opening
BAL=Balance
BTW=Between
CJ=Construction Joint
CLR=CLEARANCE
CMU=Concrete Masonry Unit
CONT=Continuous
EA=Each
Elev.=Elevation
EMB=Embedment
SW=Short Way
LW=Long Way
(BL)=Black Bar
(EP)=Epoxy Bar
(GA)=Galvanized
Shortages, improper fabrication or claims for any other reason must be reported to this company within a period of 15 days of delivery. This company reserves the right to field inspect prior to replacement or reconditioning of nonconforming material, and will not honor charges for work done in the field without specific authorization from this company.

NOTICE


REINFORCING STEEL PLACING DRAWINGS ONLY USE IN CONJUNCTION WITH CONTRACT DRAWINGS & SPECIFICATIONS. ELEVATIONS & DIMENSIONS SHOWN ON THIS DRAWING ARE FOR DETAILING PURPOSES ONLY AND SHOULD NOT BE USED FOR CONSTRUCTION UNLESS VERIFIED BY ENGINEER OR CONTRACTOR.

PROJECT	WENDELL CROSS ELEMENTARY SCHOOL	
LOCATION	WATERBURY, CONNECTICUT	
ARCHITECT	—	
ENGINEER	SZEWCAK ASSOCIATES	
CUSTOMER	G&G CONCRETE	
DRAWN BY:	DATE:	REVIEWED BY:
KAS/MRS	02/18/20	T/L
DRAWING TITLE:	AREA-A FOUNDATION WALL	DRAWING NO.:
		R7

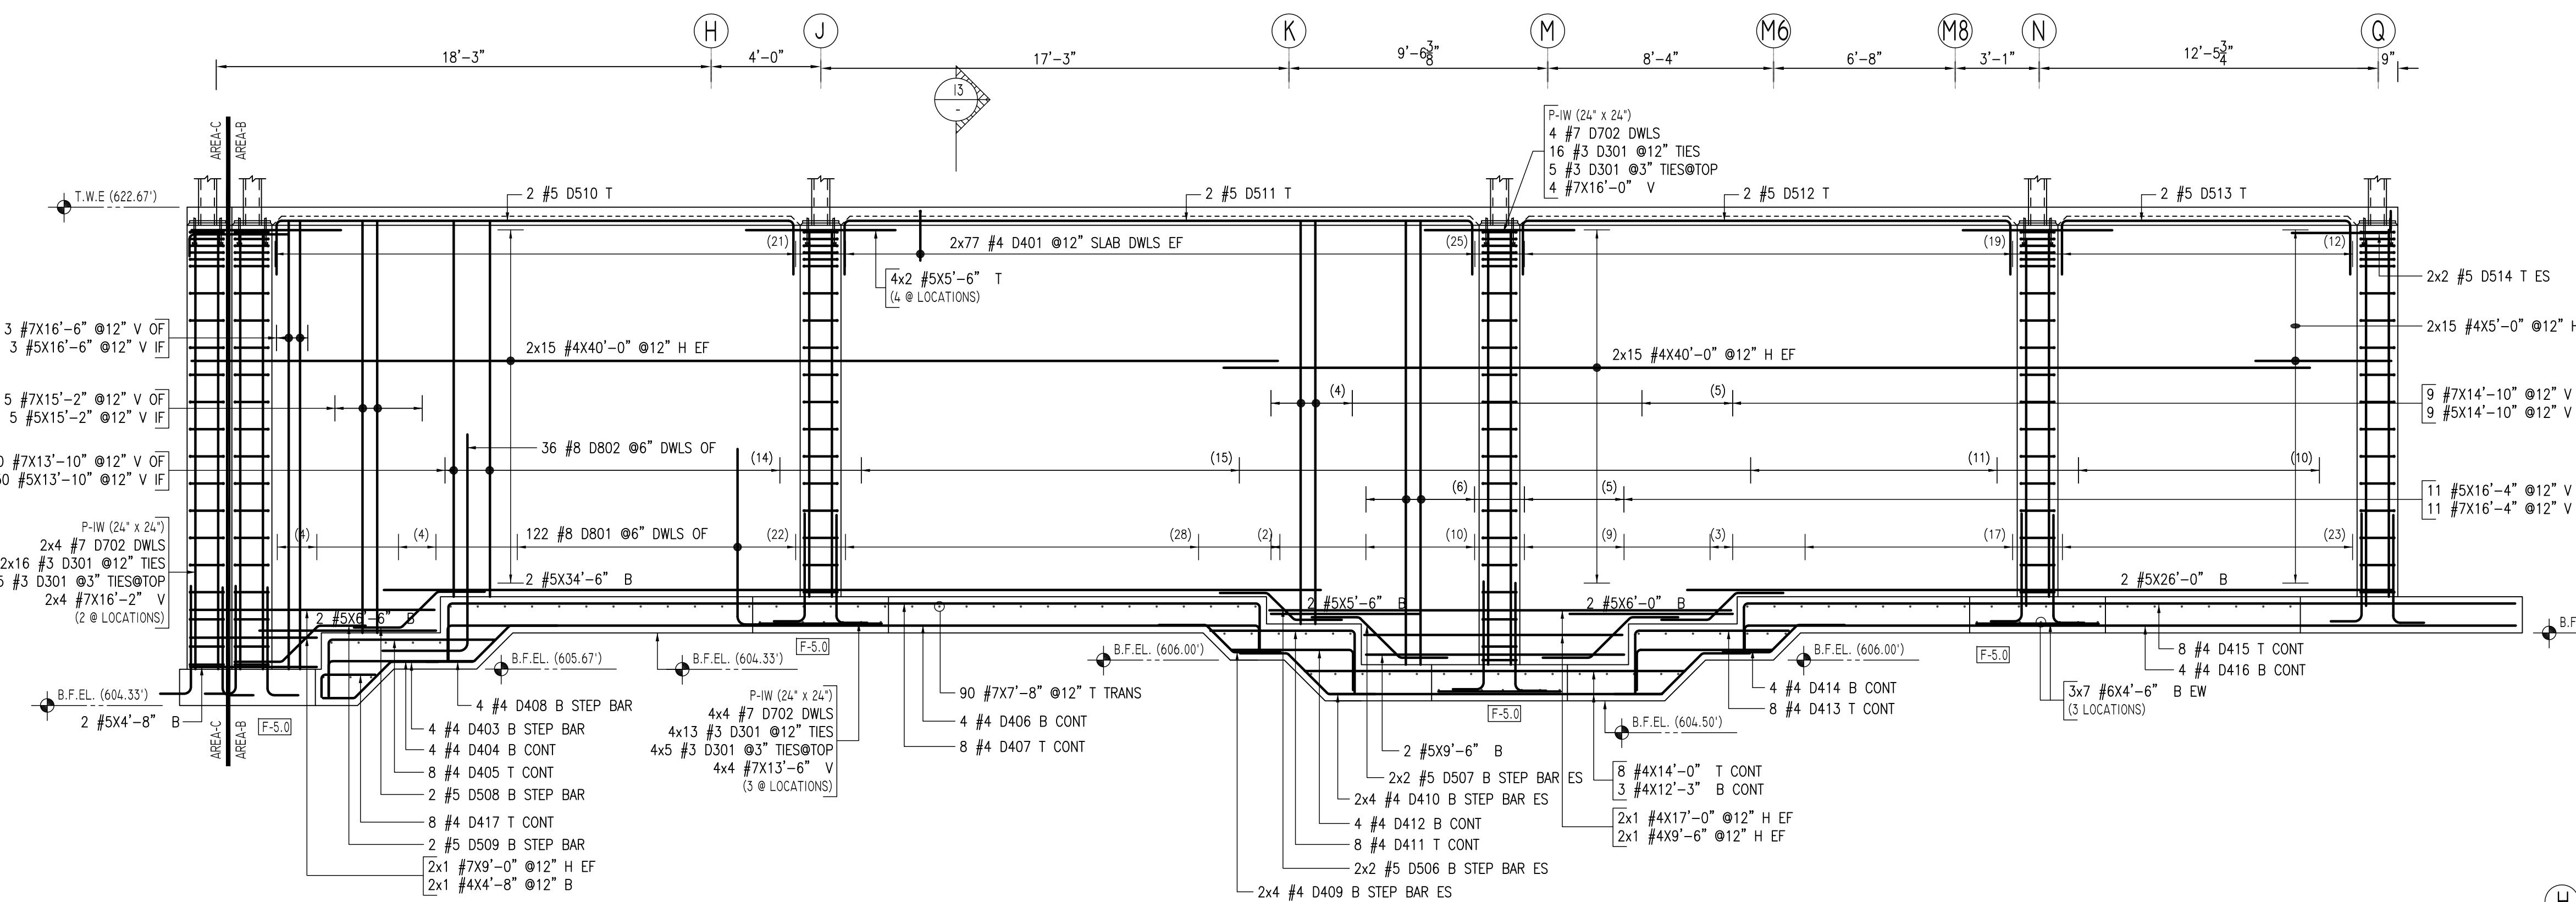

ELEVATION
- 1/4" = 1'-0"
I.I & SI.0B (DT: 10/18/19)
ONC. WALL

A/E PLEASE VERIFY,
WALL PROFILE &
REINF. DETAILS FOLLOWED (TYP.)

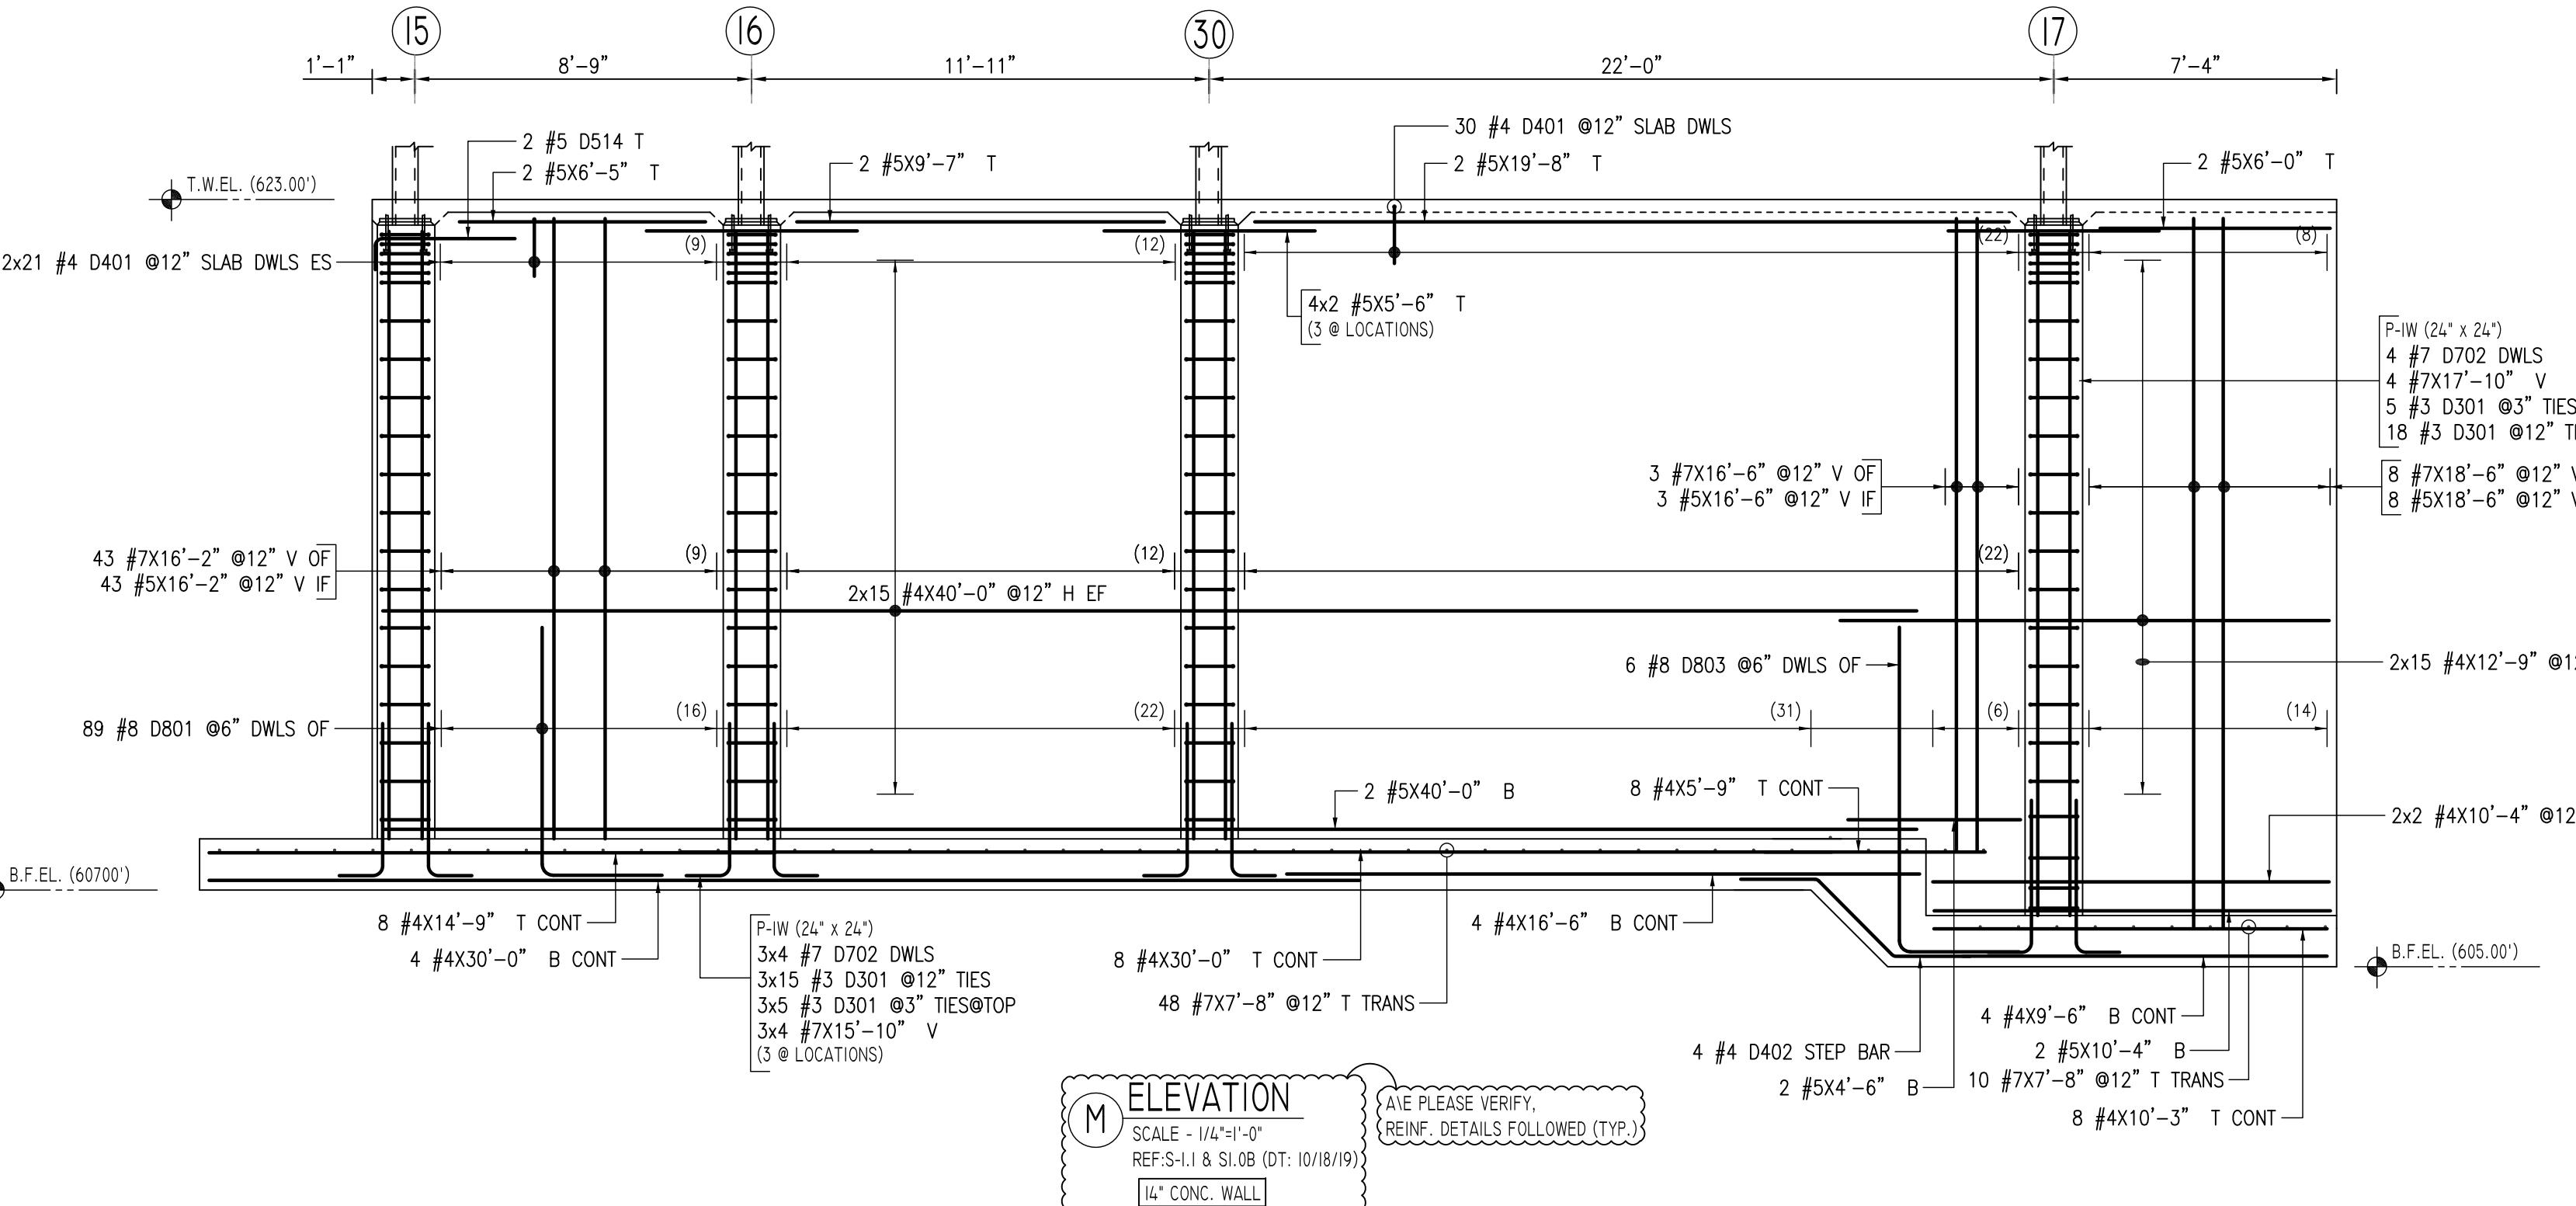

ELEVATION

M

SCALE - 1/4"=1'-0"

REF:S-I.I & SI.0B (DT: 10/18/19)

14" CONC. WALL


AVE PLEASE VERIFY,
REINF. DETAILS FOLLOWED (TYP.)

LAP SCHEDULE	
SIZE	36 X BD
	LAP
#4	18"
#5	23"
#6	27"
#7	32"


WE PLEASE VERIFY
CAP VALUE (TYP.)

TYPICAL REINFORCING BAR CLEARANCE TABLE	
LOCATION	MIN. COVER
FOOTINGS AGAINST EARTH	3" CLR
COLUMNS AND PIERS (TIES. REINF.)	1 1/2" CLR
WALLS INTERIOR FACE	1 1/2" CLR
WALLS EXTERIOR FACE (#5 & SMALLER)	1 1/2" CLR
WALLS INTERIOR FACE (#6 & LARGER)	2" CLR
WALLS EXTERIOR FACE (#6 & LARGER)	2" CLR


ALL BARS IN THIS DRAWING
ASTM A615 GRADE 60
BLACK UNCOATED

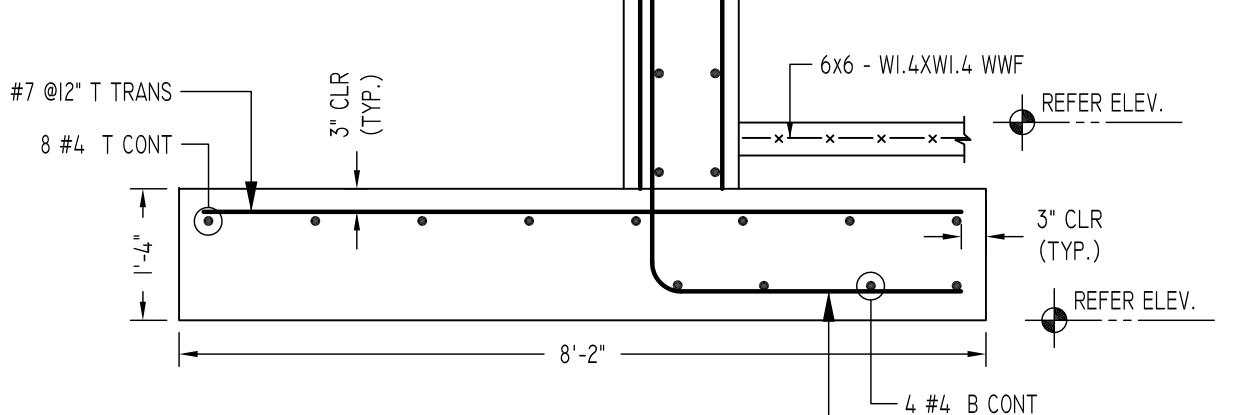

13 SECTION
SCALE - 1/2"=1'-0"

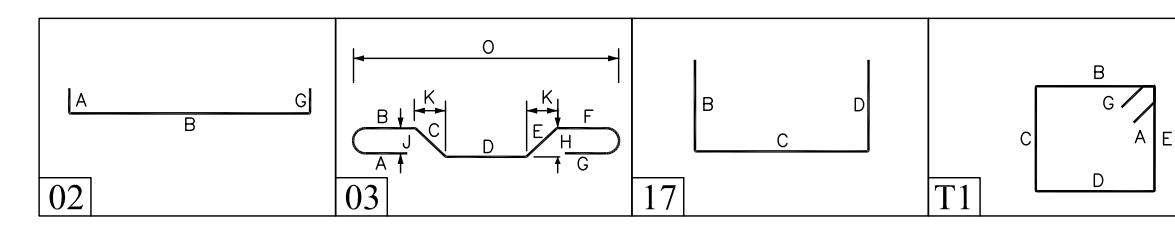

(H) (K) (M) (M6) (N) (Q) (Q.2) (Q.6) (R) (R.4) (S) (T) (U) (V)

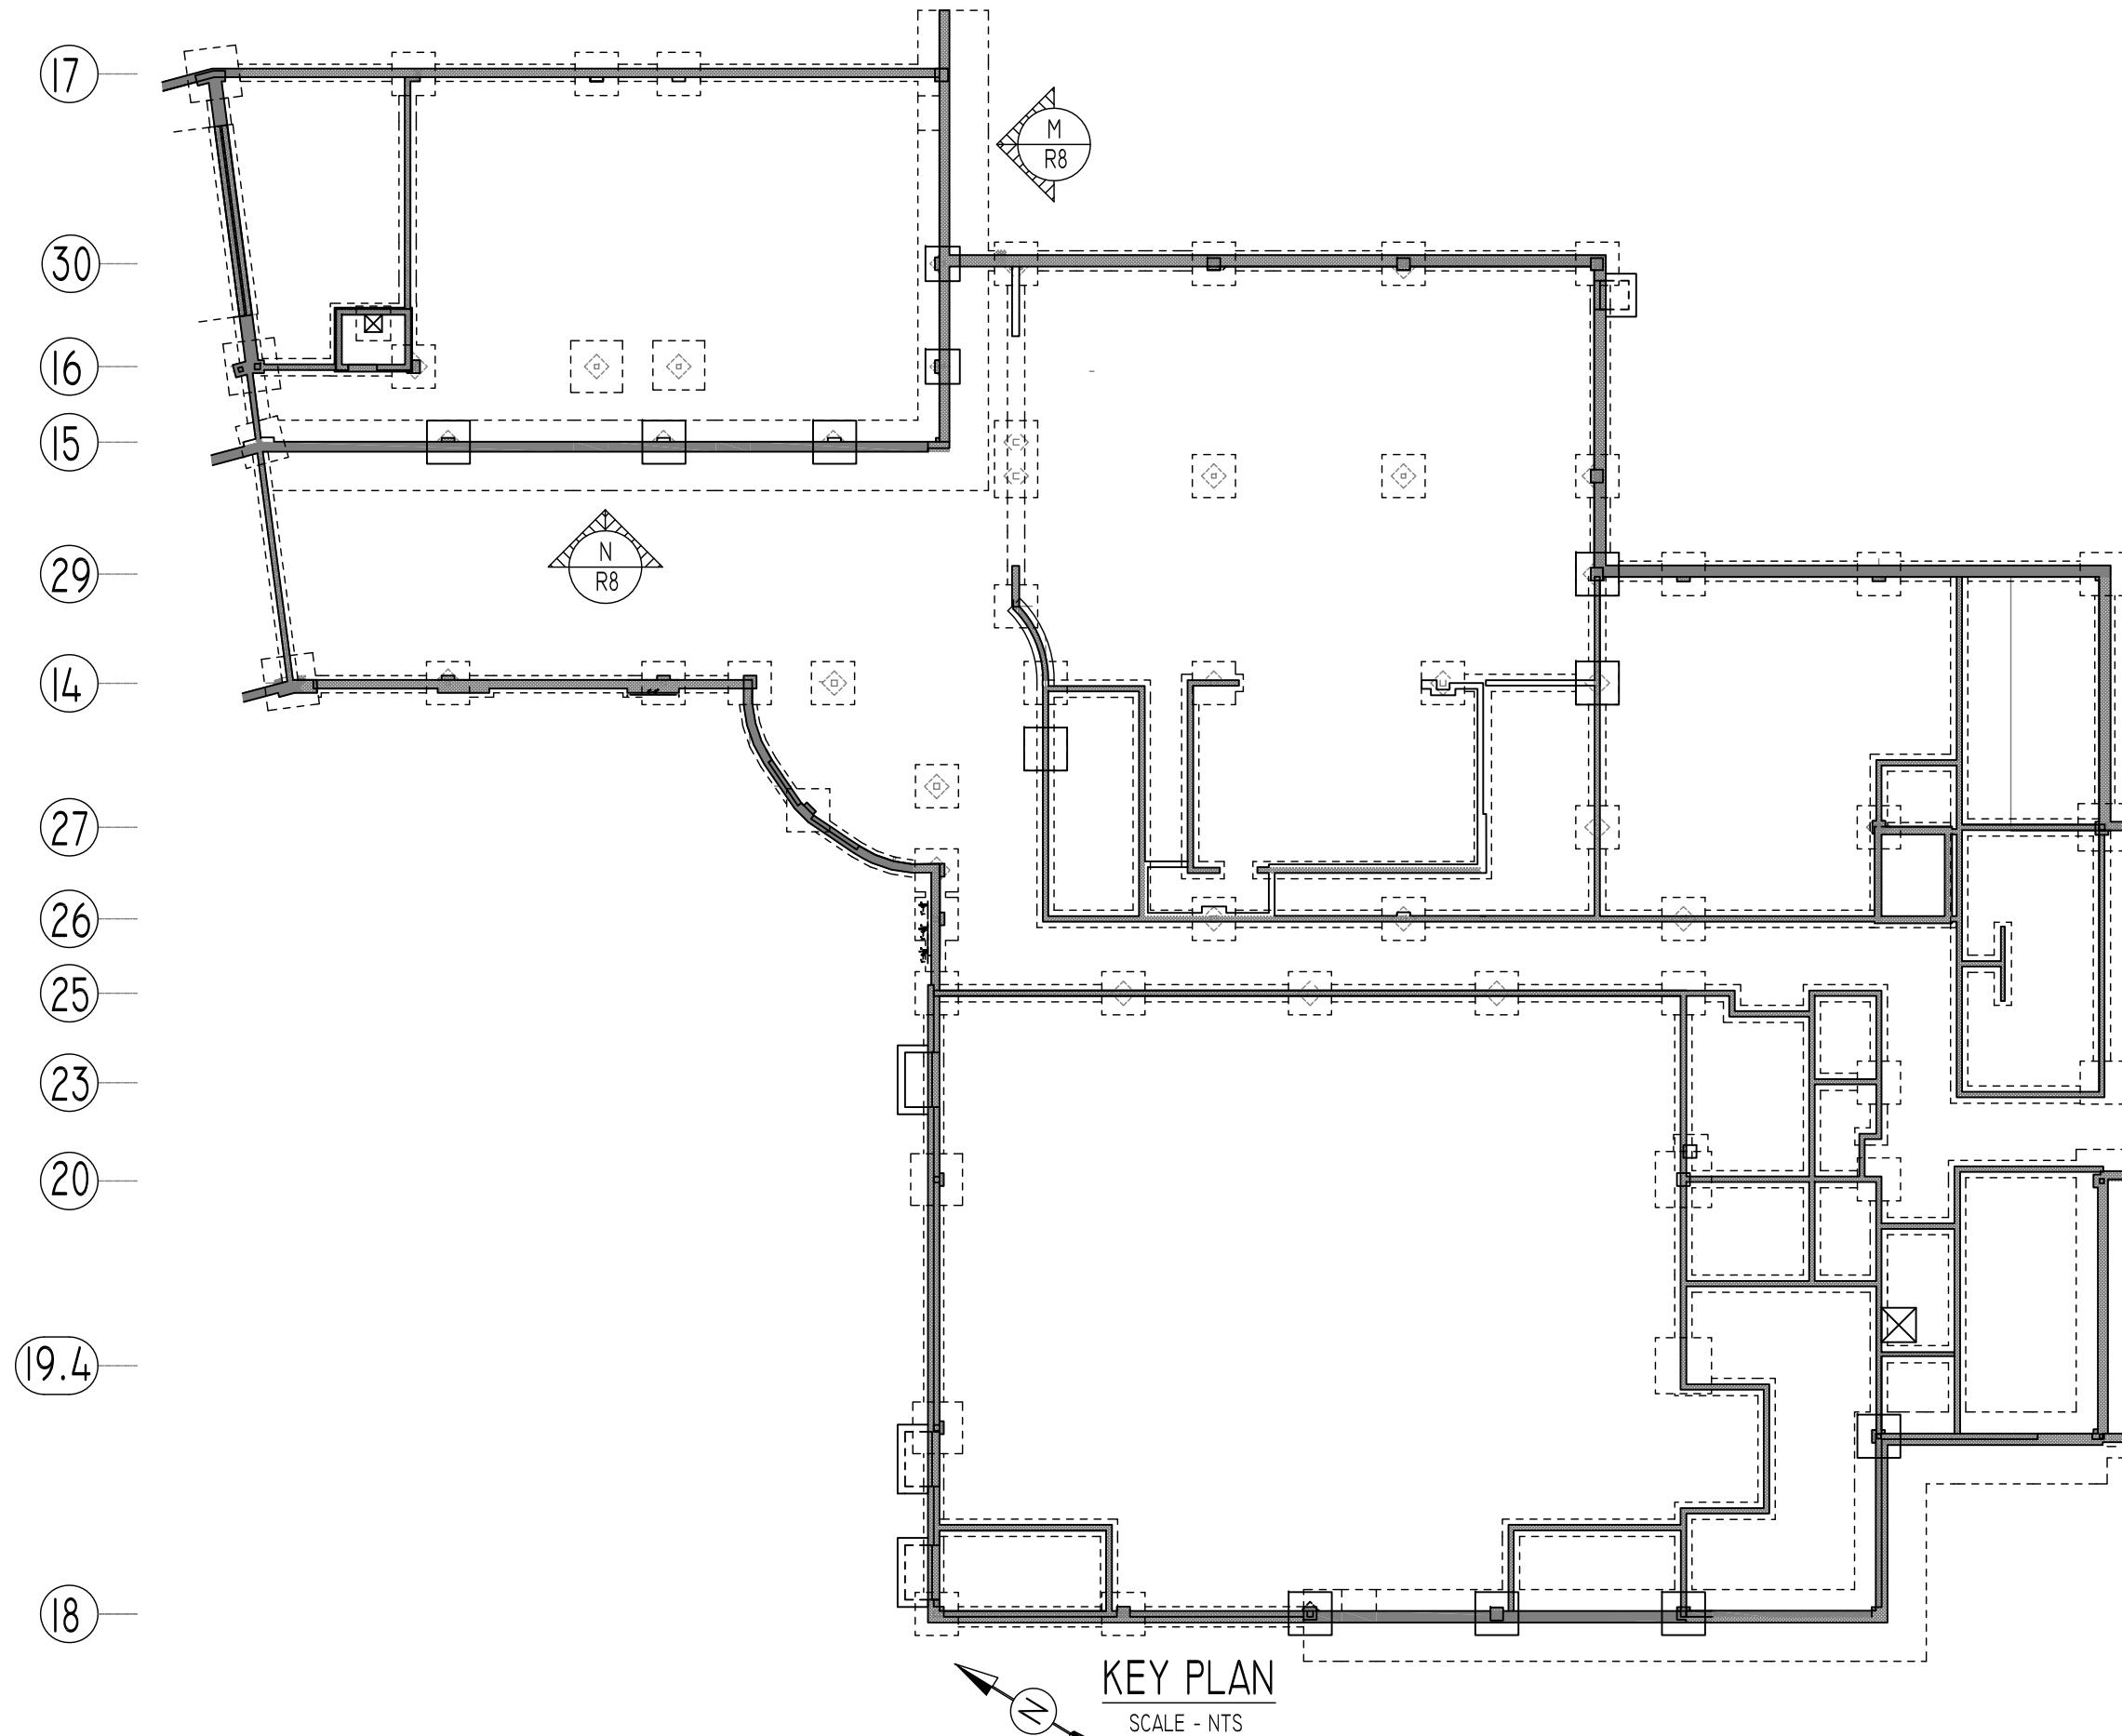

REVISION MARK	REVISION DETAILS	DATE
0	FOR APPROVAL	02/18/2024

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For more information about the study, please contact Dr. [REDACTED] at [REDACTED].

WENDELL CROSS ELEMENTARY SCHOOL

WATERBURY, CONNECTICUT

SZEWCZAK ASSOCIATES

G&G CONCRETE


6 02/18/20 T/L 20009
DRAFTING NO.:

A-A FOUNDATION WALL
SECTION M & N REINFORCEMENT DETAIL


ANSWER

NOTICE


ry Unit	honor charges for work done in the field without specific authorization from this company.
	<p>REINFORCING STEEL PLACING DRAWINGS ONLY USE IN CONJUNCTION WITH CONTRACT DRAWINGS & SPECIFICATIONS. ELEVATIONS & DIMENSIONS SHOWN ON THIS DRAWING ARE FOR DETAILING PURPOSES ONLY AND SHOULD NOT BE USED FOR CONSTRUCTION UNLESS VERIFIED</p>

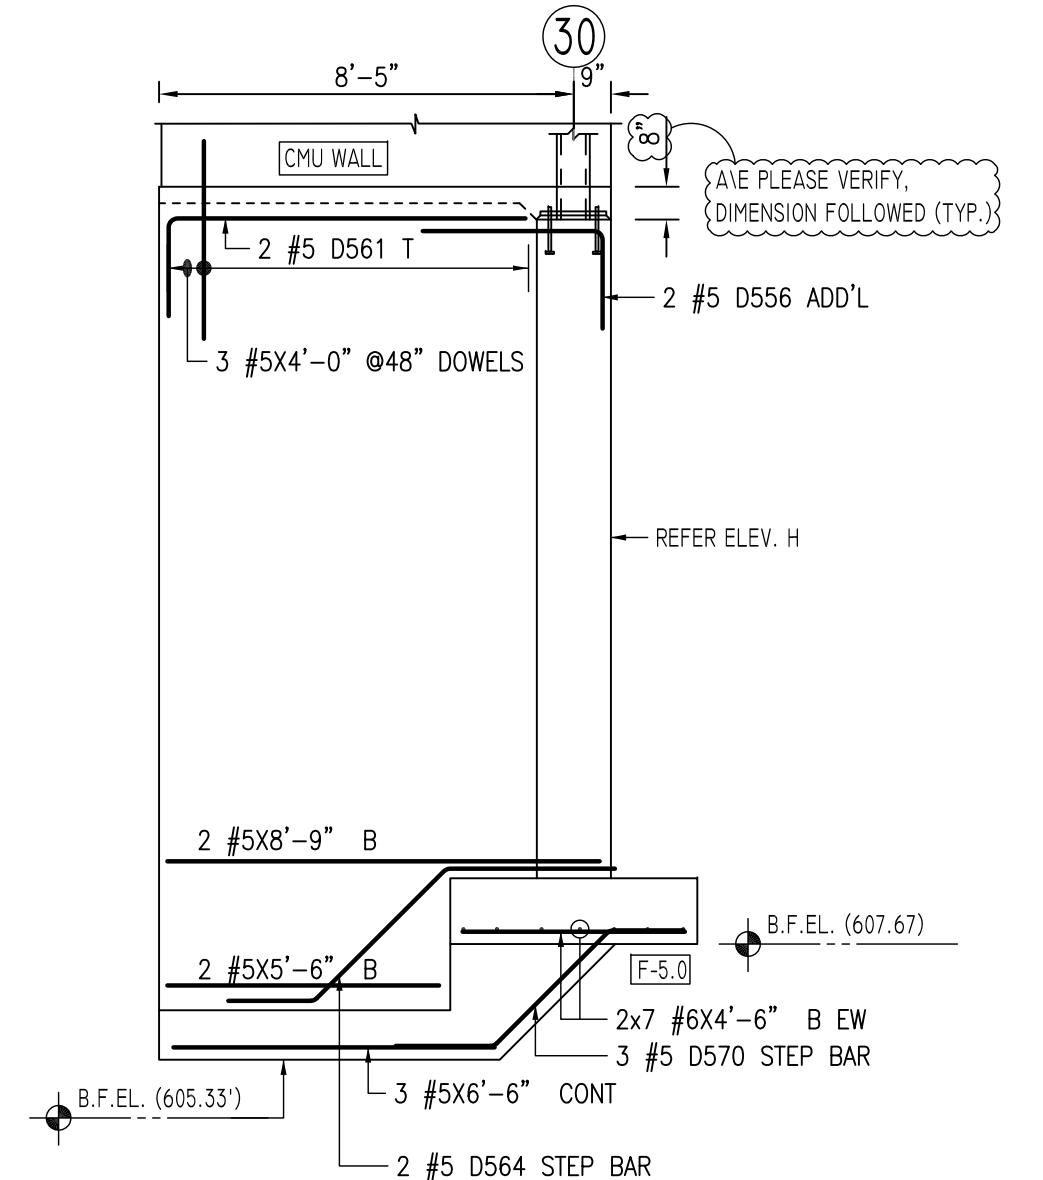


P ELEVATION
SCALE - 1/4"=1'-0"
REF-S-I.1 & S.I.08 (DT: 10/18/19)
16" CONC. WALL

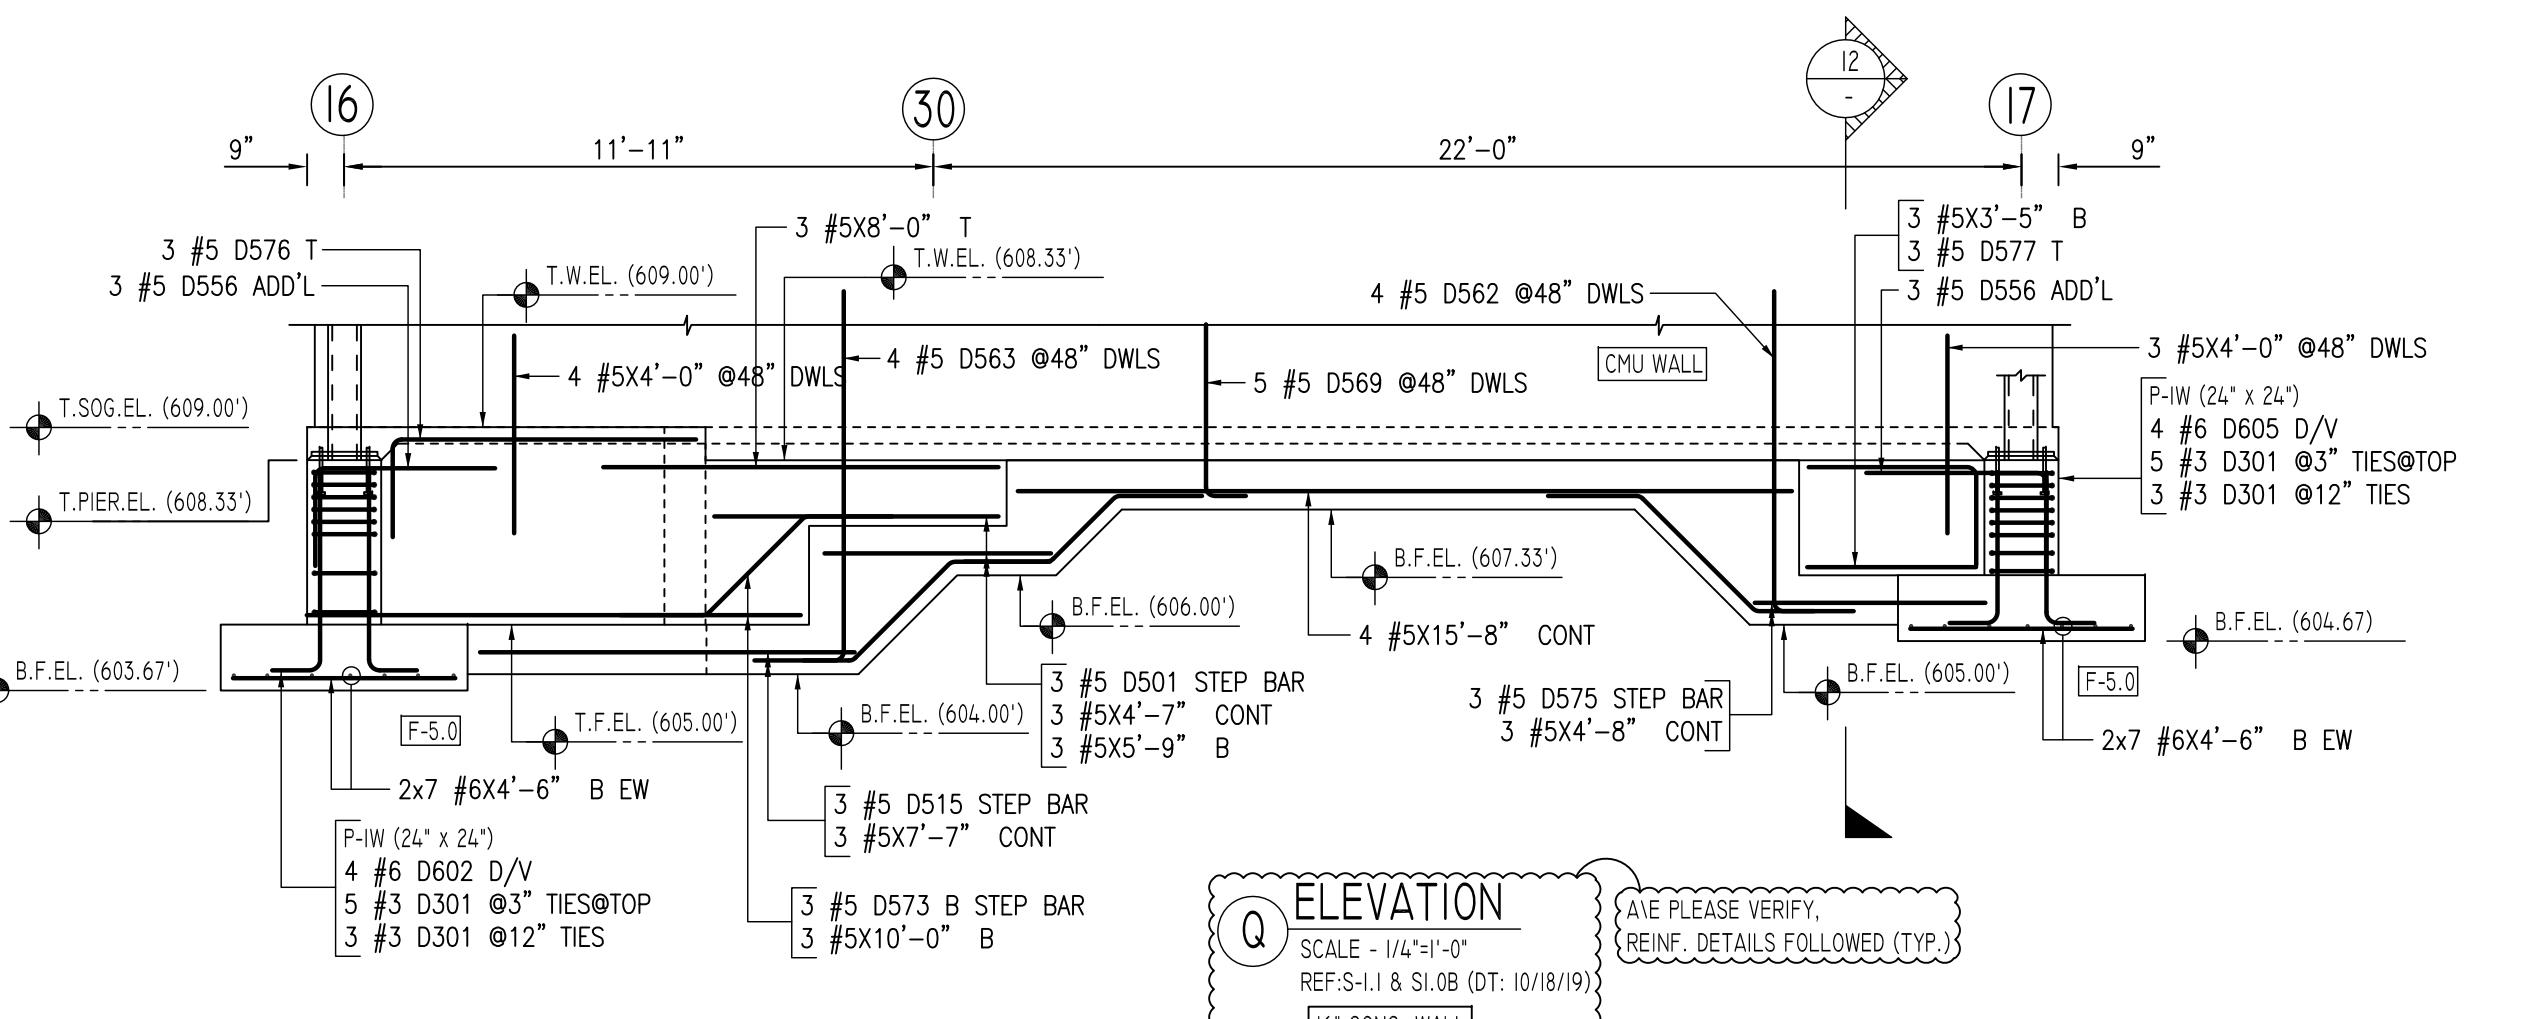


Q ELEVATION
SCALE - 1/4"=1'-0"
REF-S-I.1 & S.I.08 (DT: 10/18/19)
16" CONC. WALL

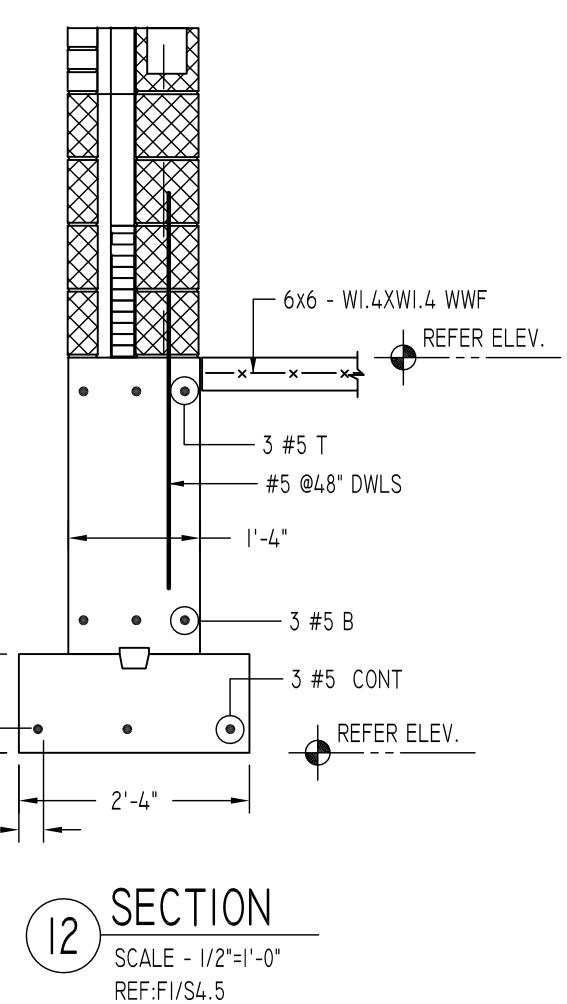


12 SECTION
SCALE - 1/2"=1'-0"
REF-F.I/S4.5

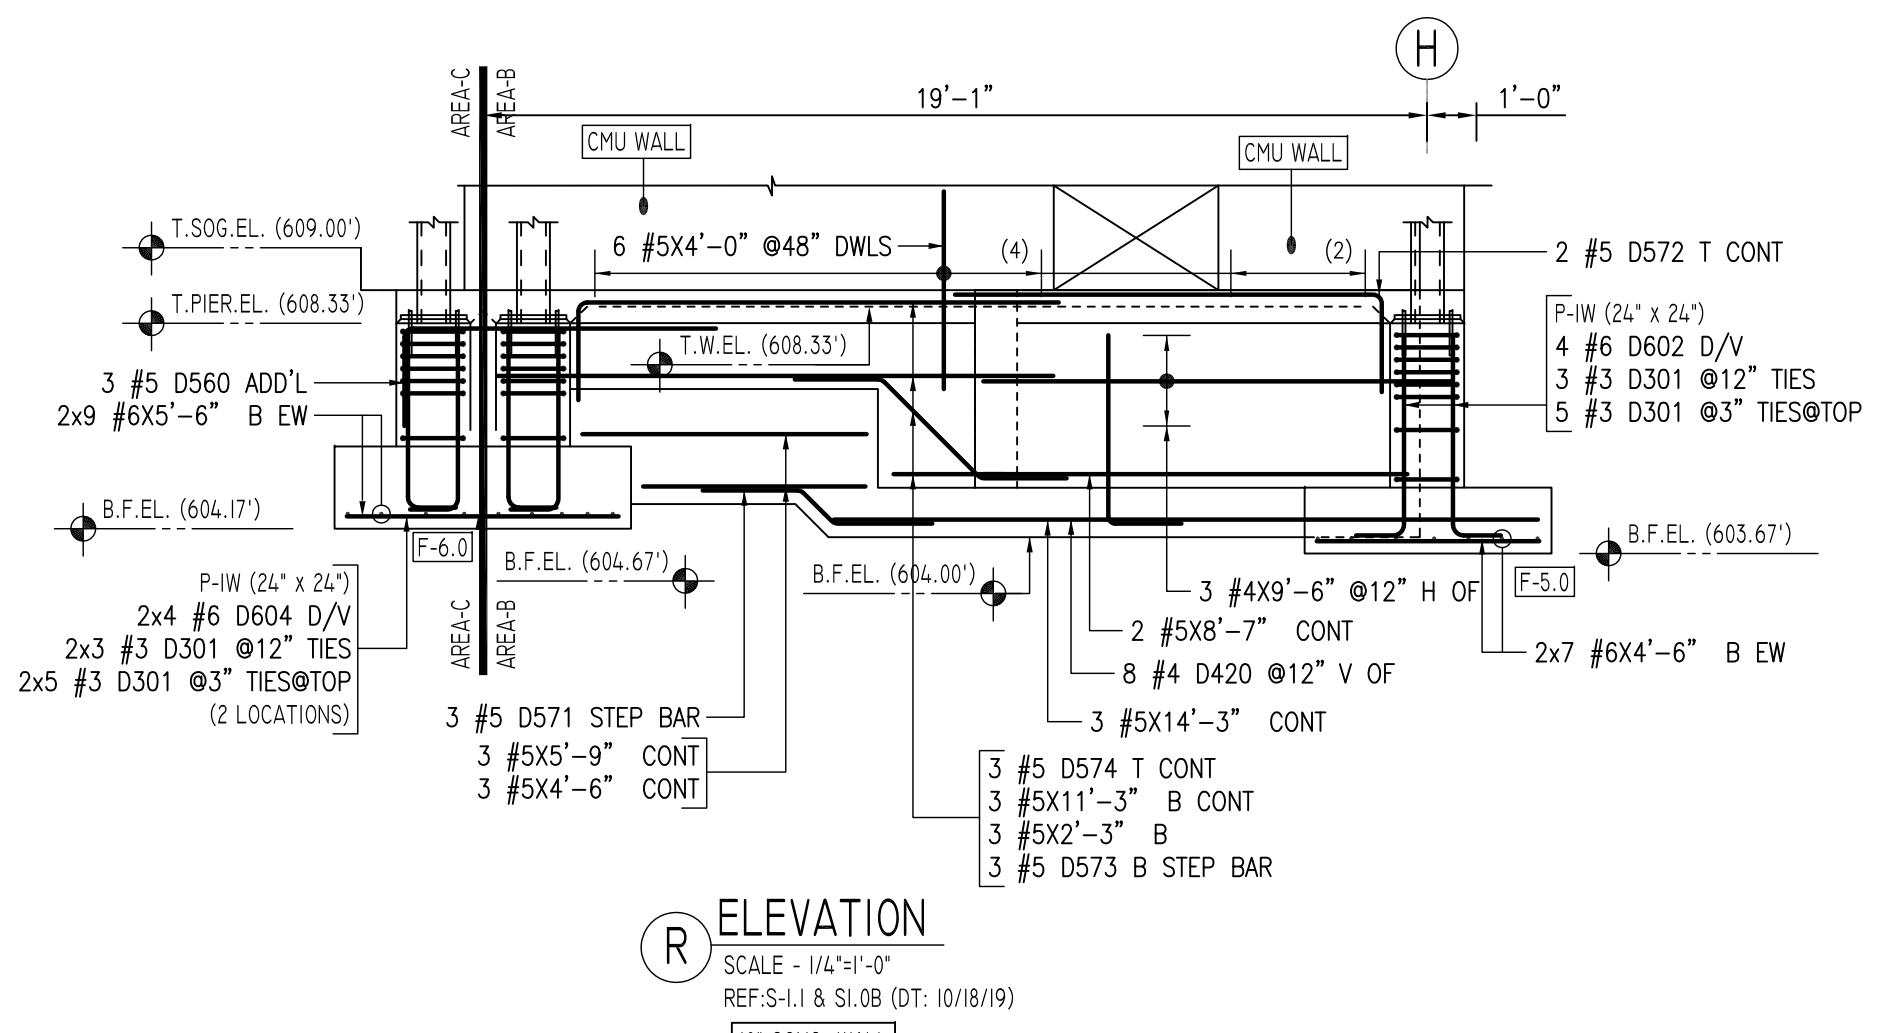


R ELEVATION
SCALE - 1/4"=1'-0"
REF-S-I.1 & S.I.08 (DT: 10/18/19)
10" CONC. WALL

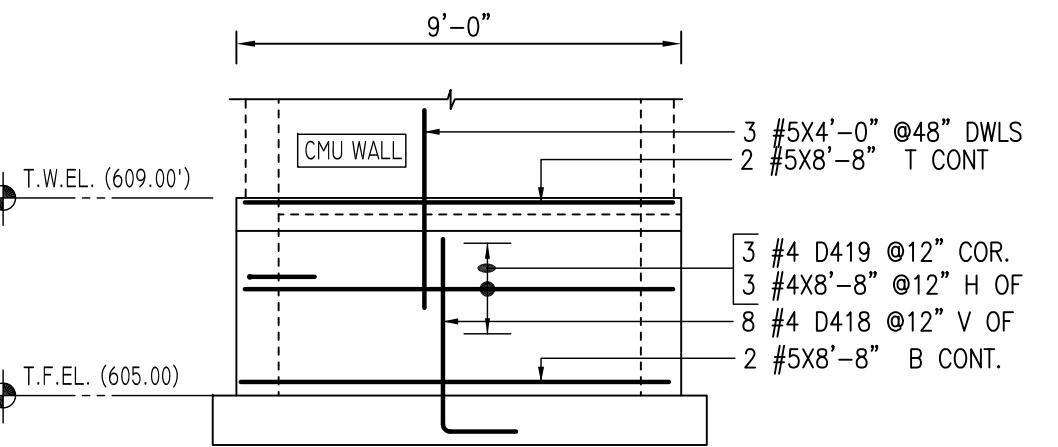


S ELEVATION
SCALE - 1/4"=1'-0"
REF-S-I.1 & S.I.08 (DT: 10/18/19)
10" CONC. WALL

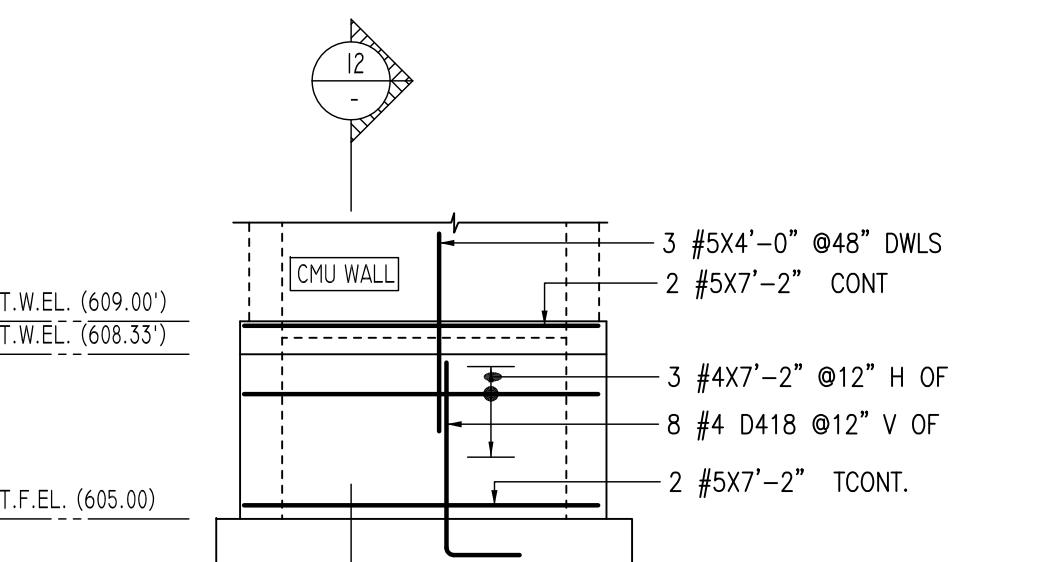

T ELEVATION
SCALE - 1/4"=1'-0"
REF-S-I.1 & S.I.08 (DT: 10/18/19)
10" CONC. WALL

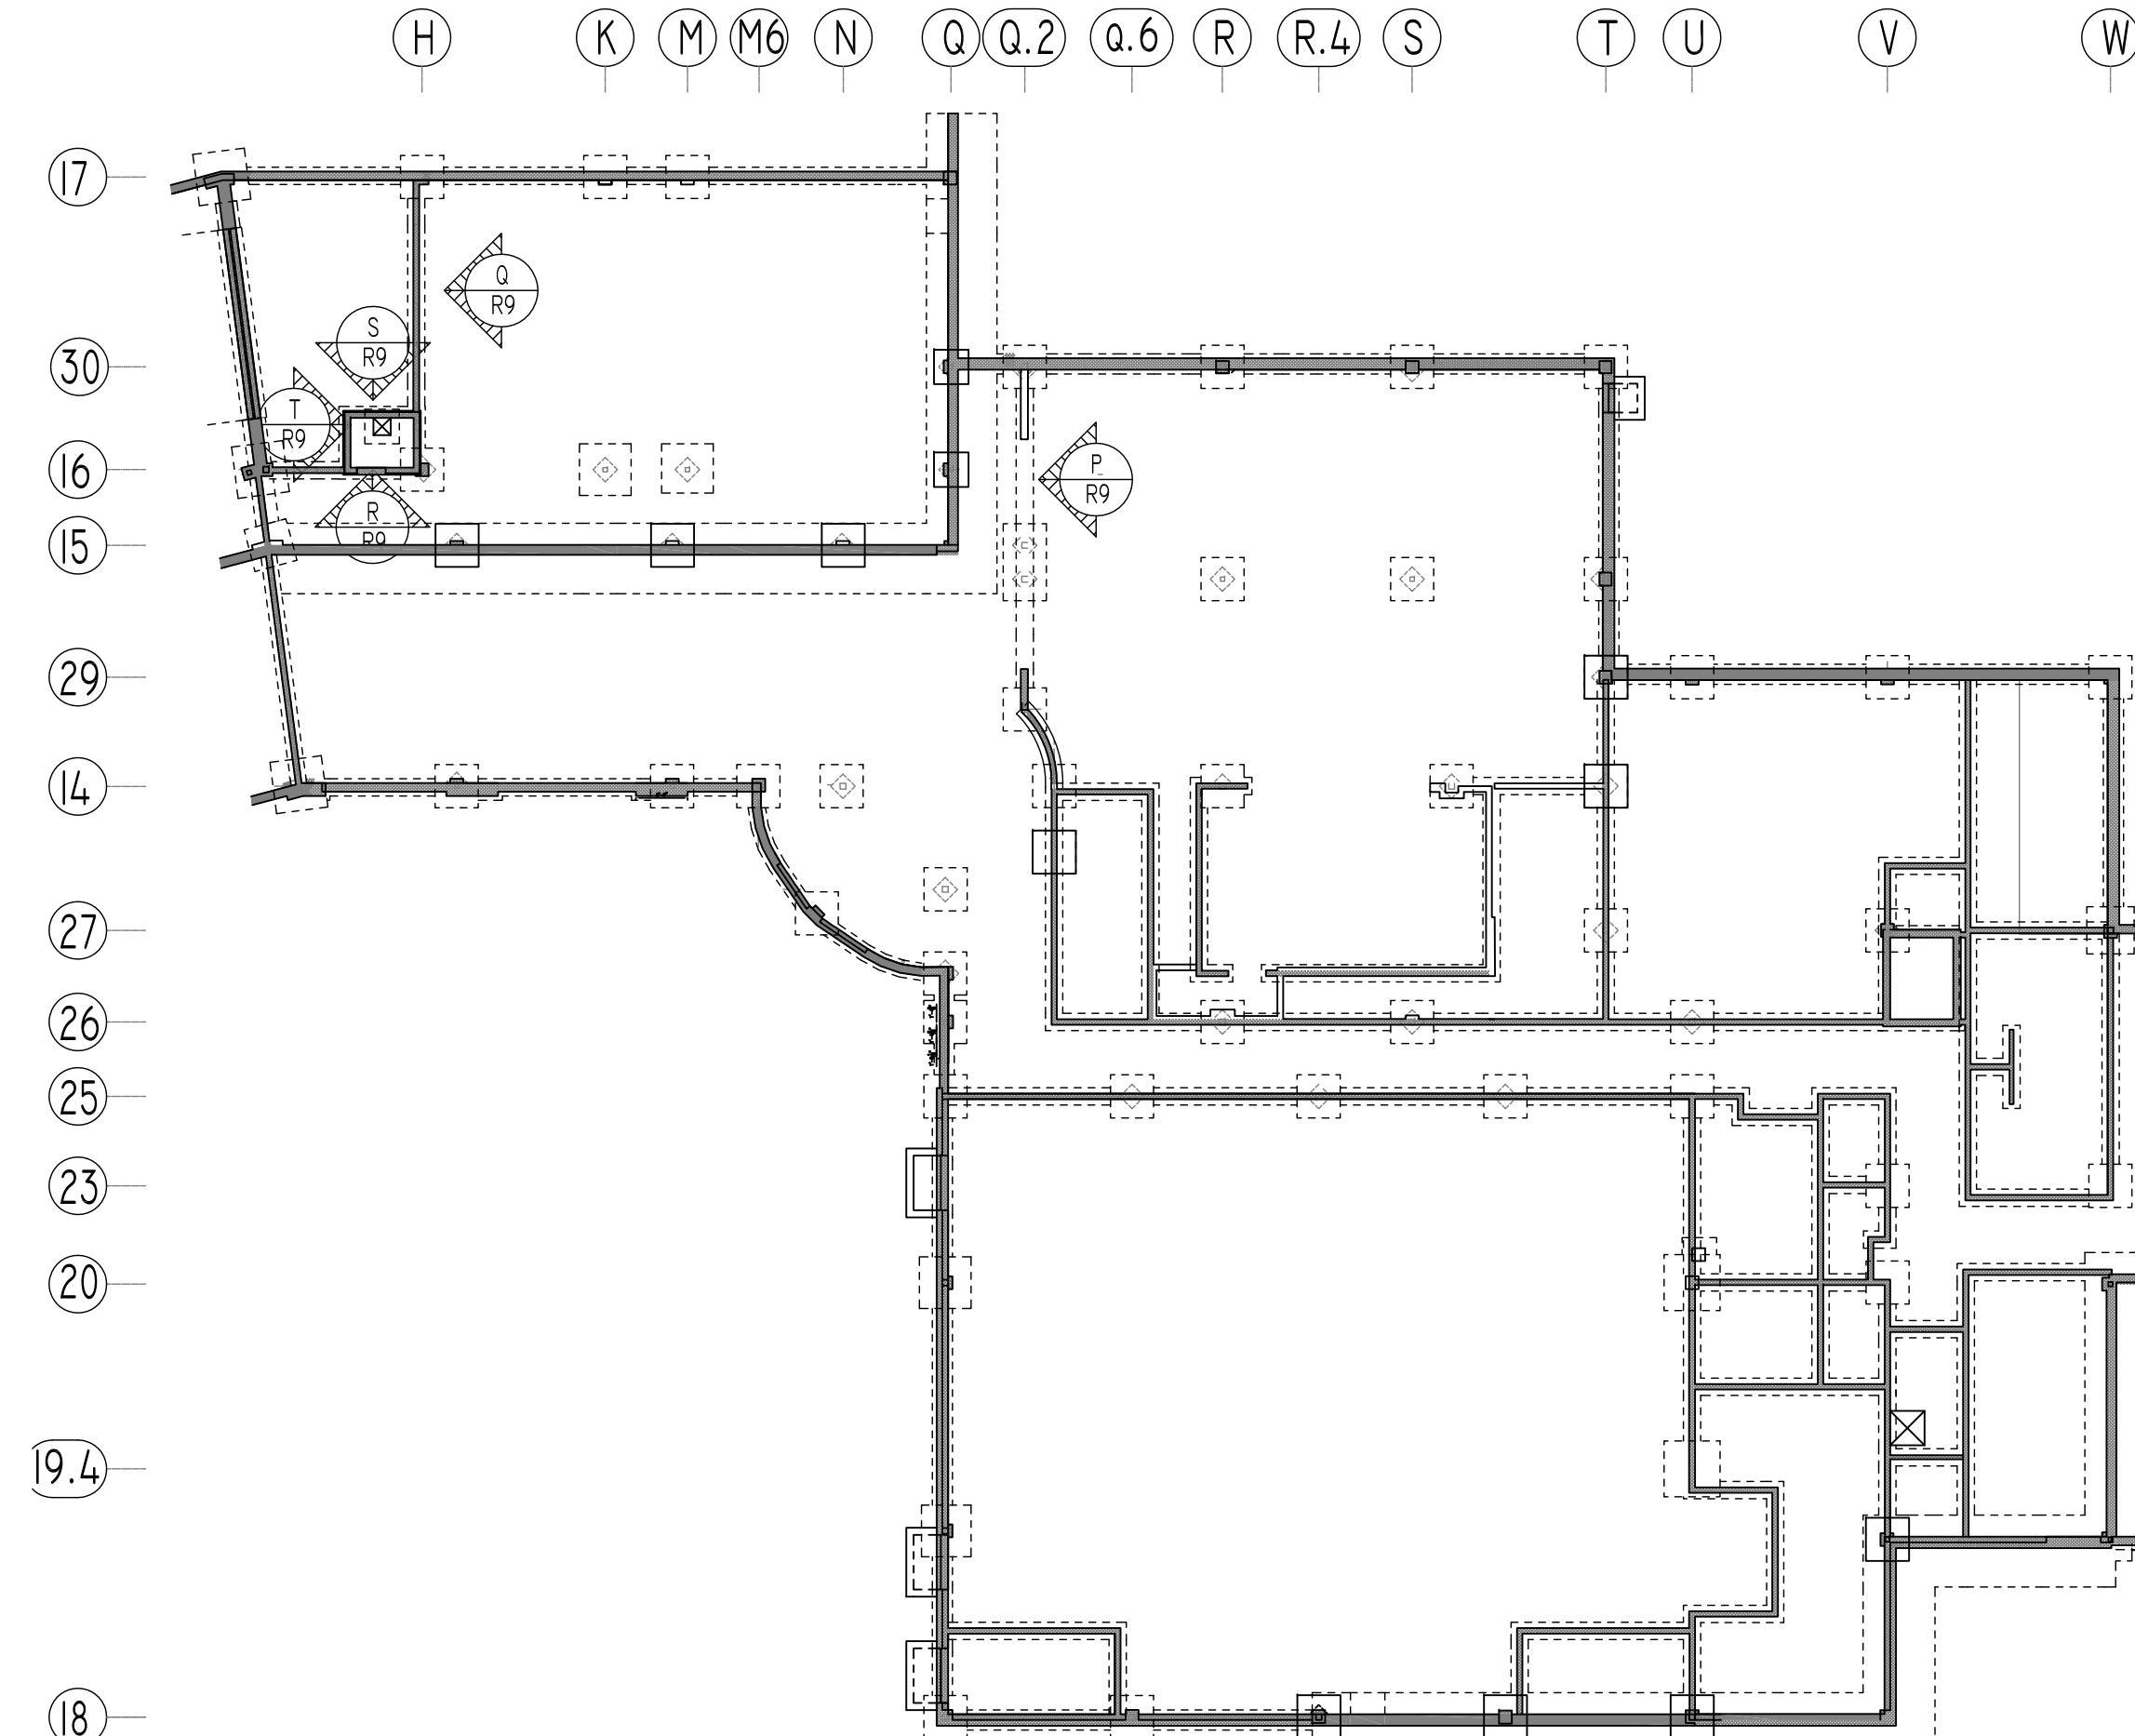

BENDING DETAILS.																	
Bar Work	Qty	Size	Total length	Type	'A'	'B'	'C'	'D'	'E'	'F'	'G'	'H'	'I'	'J'	'K'	'L'	'M'
D301	40 #3	5/8" 11	4"	I.F.	13"	13"	13"	13"	13"	4"	2 1/2"						
D418	16 #4	5 5/8" 17	16"	O.F.	31 1/2"												
D419	3 #4	2 8" 17	14"	E.F.	14"												
D420	8 #4	5 4" 17	16"	BETWEEN	31 1/2"												
D501	3 #5	5 4" X 3	19"	TIES@TOP	110 1/2"	19"					14 1/2"		13 1/2"	4 1/2"			
D515	3 #5	6 10" 3	20"	20" X 20"	20"	38"					20 1/2"		111 1/2"	5 1/2"			
D556	8 #5	5 8" 17	20"	20"	20"												
D560	3 #5	8 4" 17	20"	20"	64"												
D561	2 #5	9 3" 17	20"	20"	73"												
D562	4 #5	7 4" 2	10"	H.O.F.	66"												
D563	4 #5	8 4" 2	10"	V.O.F.	76"												
D564	2 #5	8 11 1/2" 3	35"	39 1/2"	19"						28 1/2"		27 1/2"	79 1/2"			
D569	5 #5	4 4" 2	10"	20"	36"												
D570	3 #5	6 10" 3	16"	34"	20"						24 1/2"		23 1/2"	5 1/2"			
D571	3 #5	4 11 1/2" 3	20"	11 1/2"	20"						8 1/2"		7 1/2"	4 1/2"			
D572	2 #5	10 8" 17	20"	20"	88"						20 1/2"		111 1/2"	55 1/2"			
D573	6 #5	6 4" X 3	19 1/2"	20"	19"						20 1/2"		111 1/2"	55 1/2"			
D574	3 #5	11 9" 17	20"	20"	99"												
D575	3 #5	72 4" 3	110 1/2"	33 1/2"	20"						24 1/2"		23 1/2"	62"			
D576	3 #5	8 2" 17	20"	20"	62"												
D577	3 #5	55" 17	20"	20"	35"												
D602	8 #6	5 1" 2	10"	41"													
D604	8 #6	4 7 1/2" 2	10"	37 1/2"													
D605	4 #6	4 1" 2	10"	31"													

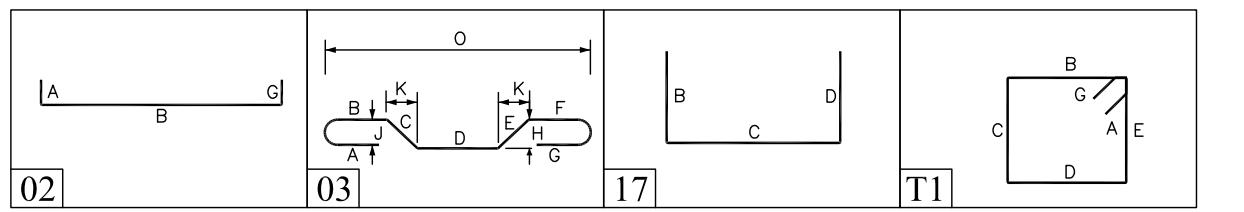

LAP SCHEDULE	
SIZE	36 X BD
LAP	LAP
#4	18"
#5	23"
#6	27"
#7	32"

TYPICAL REINFORCING BAR CLEARANCE TABLE	
LOCATION	MIN. COVER
FOOTINGS AGAINST EARTH	3" CLR
COLUMNS AND PIERS (TIES, REINF.)	1 1/2" CLR
WALLS INTERIOR FACE	2" CLR
WALLS EXTERIOR FACE (#5 & SMALLER)	1 1/2" CLR
WALLS INTERIOR FACE (#6 & LARGER)	2" CLR
WALLS EXTERIOR FACE (#6 & LARGER)	2" CLR

ALL BARS IN THIS DRAWING
ASTM A615 GRADE 60
BLACK UNCOATED

A/E PLEASE VERIFY
COVER VALUE (TYP.)


A/E PLEASE VERIFY
LAP VALUE (TYP.)

Abbreviations:
IF=Inside Face
O.F.=Outside Face
E.F.=Each Face
BTW=Between
CI=Construction Joint
V=Vertical
H=Horizontal
CR=Corner Bar
SDW=Slab Dowel
E.W.=Each Way
BOT=Bottom
T=Top
MDW=Masonry Dowel
B.B.=Bond Beam
ALT=Alternate
Approx=Approximate
EA=Each
Elev=Elevation
EMB=Embedment
SW=Short Way
LW=Long Way
(BL)=Black Bar
(EP)=Epoxy Bar
(GA)=Galvanized

OPNG=Opening
BAL=Balance
BTW=Between
CLR=CLEARANCE
CMU=Concrete Masonry Unit
CONT=Continuous
EACH=Each
NOTICE
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REINFORCING STEEL PLACING DRAWINGS ONLY USE IN CONJUNCTION
WITH CONTRACT DRAWINGS & SPECIFICATIONS. ELEVATIONS &
DIMENSIONS SHOWN ON THIS DRAWING ARE FOR DETAILING PURPOSES
ONLY AND SHOULD NOT BE USED FOR CONSTRUCTION UNLESS VERIFIED
BY ENGINEER OR CONTRACTOR.

PROJECT WENDELL CROSS ELEMENTARY SCHOOL
LOCATION WATERBURY, CONNECTICUT
ARCHITECT —
ENGINEER SZEWCAK ASSOCIATES
CUSTOMER G&G CONCRETE
DRAWN BY: KAS/MRS DATE: 02/18/20 JOB NO: 20009
REVISED BY: T/L DRAWING NO.:
DRAWING TITLE: ÁREA-A FOUNDATION WALL
ELEVATION P TO T REINF. DETAIL
DRAWING NUMBER: R9

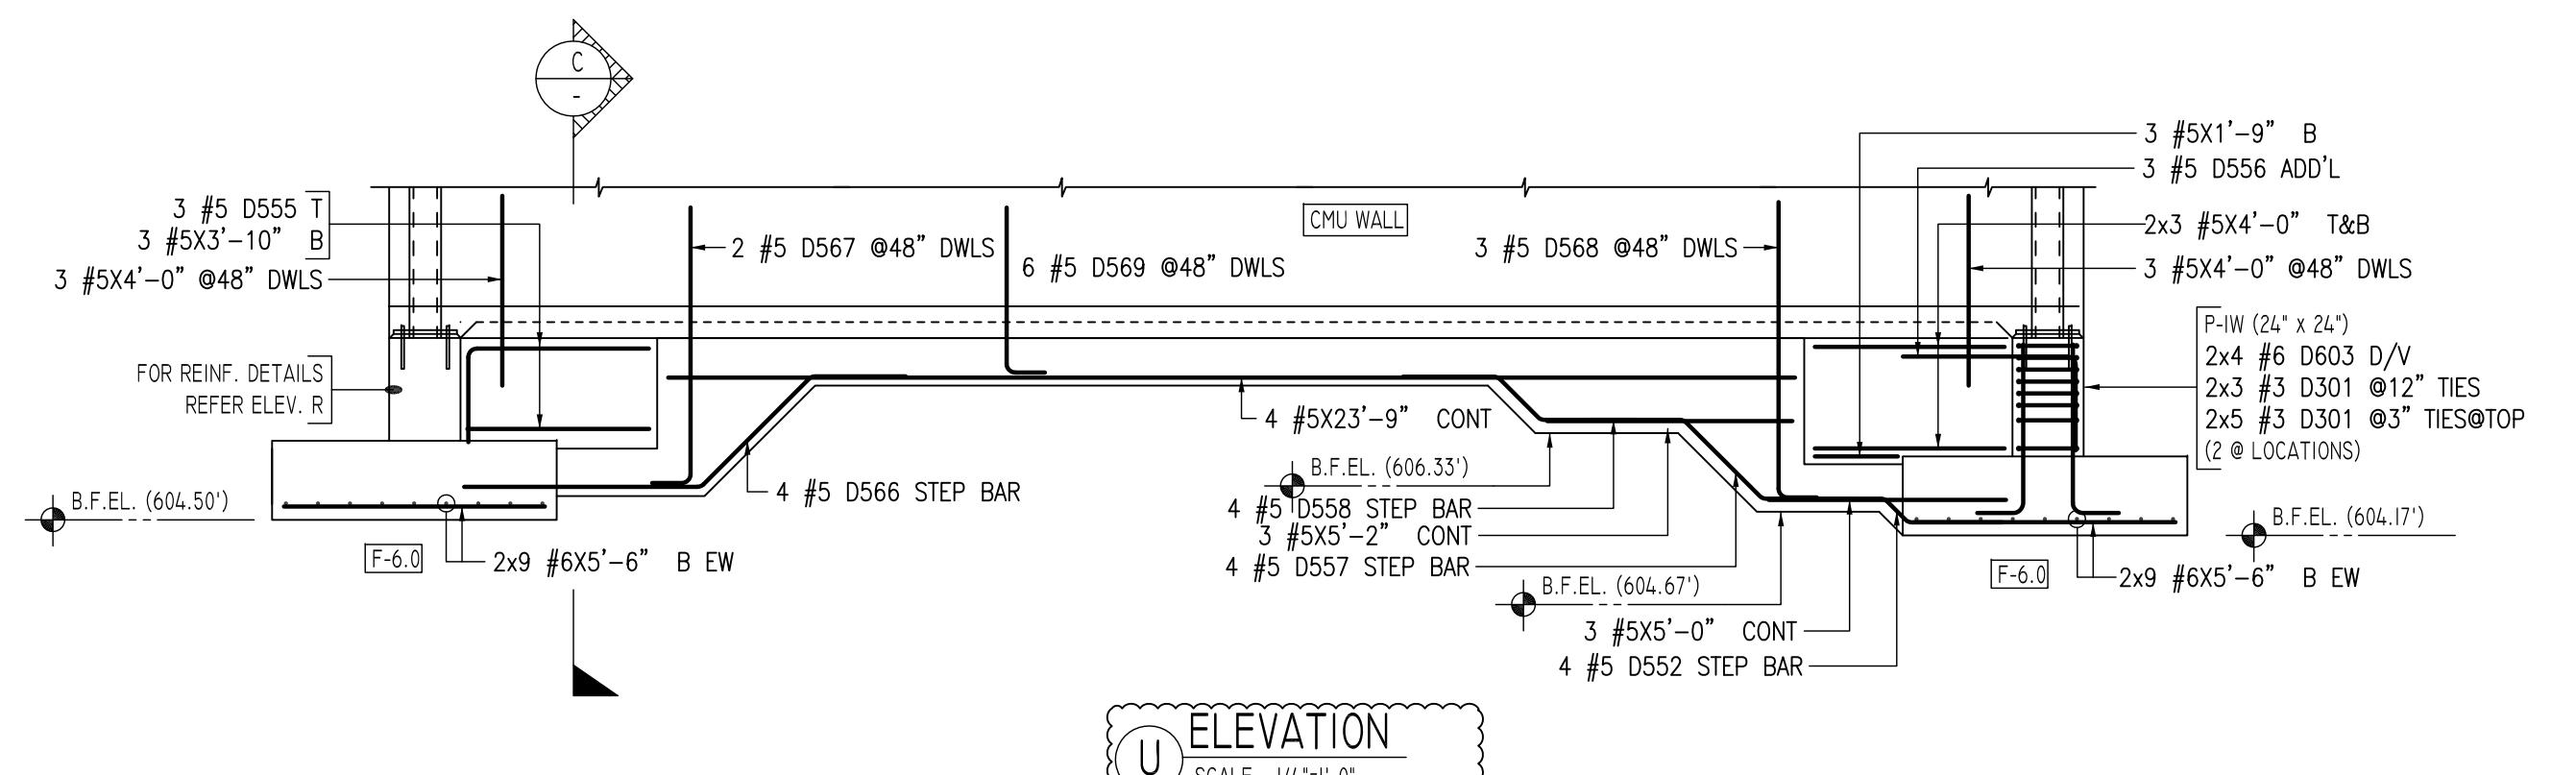


ELEVATION


SCALE - 1/4"=1'-0"

REF:S-I.I & SI.0B (DT: 10/18/19)

16" CONC. WALL


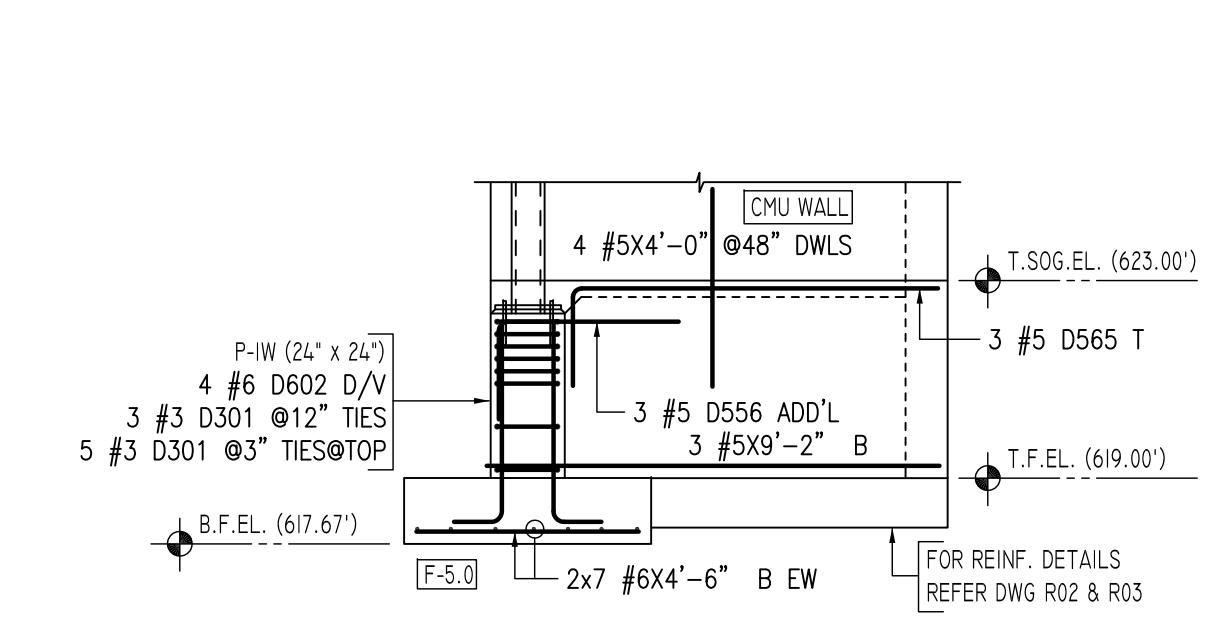


4 #5X4-U @48 DWLS
T.SOG.EL. (623)

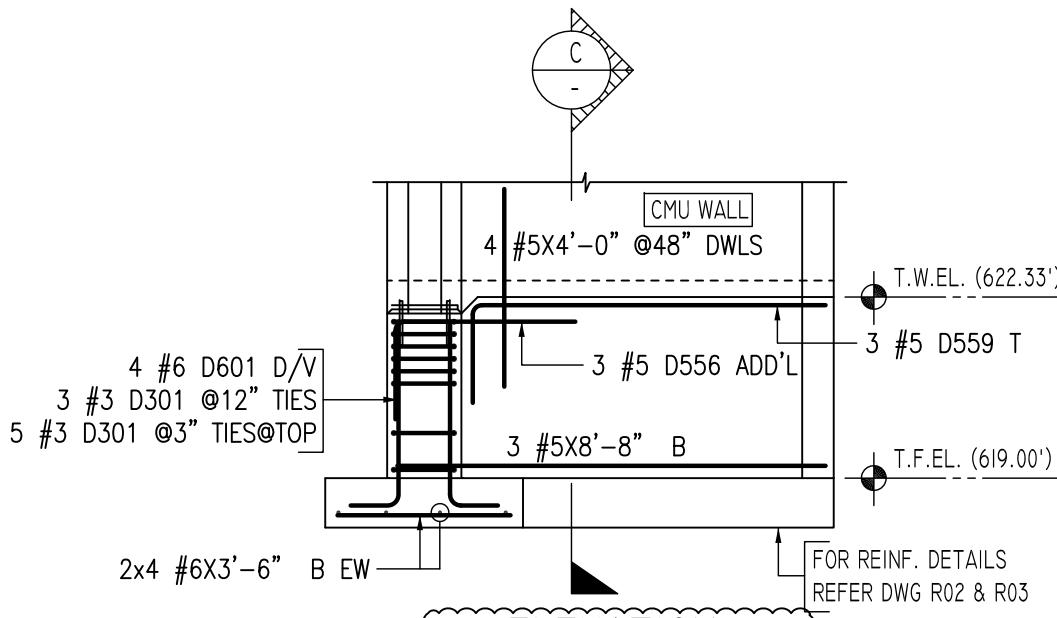


2x4 #6X3-6 B EW —————  FOR REINFORCING DETAILS
REFER DWG R02 & R03


 ELEVATION

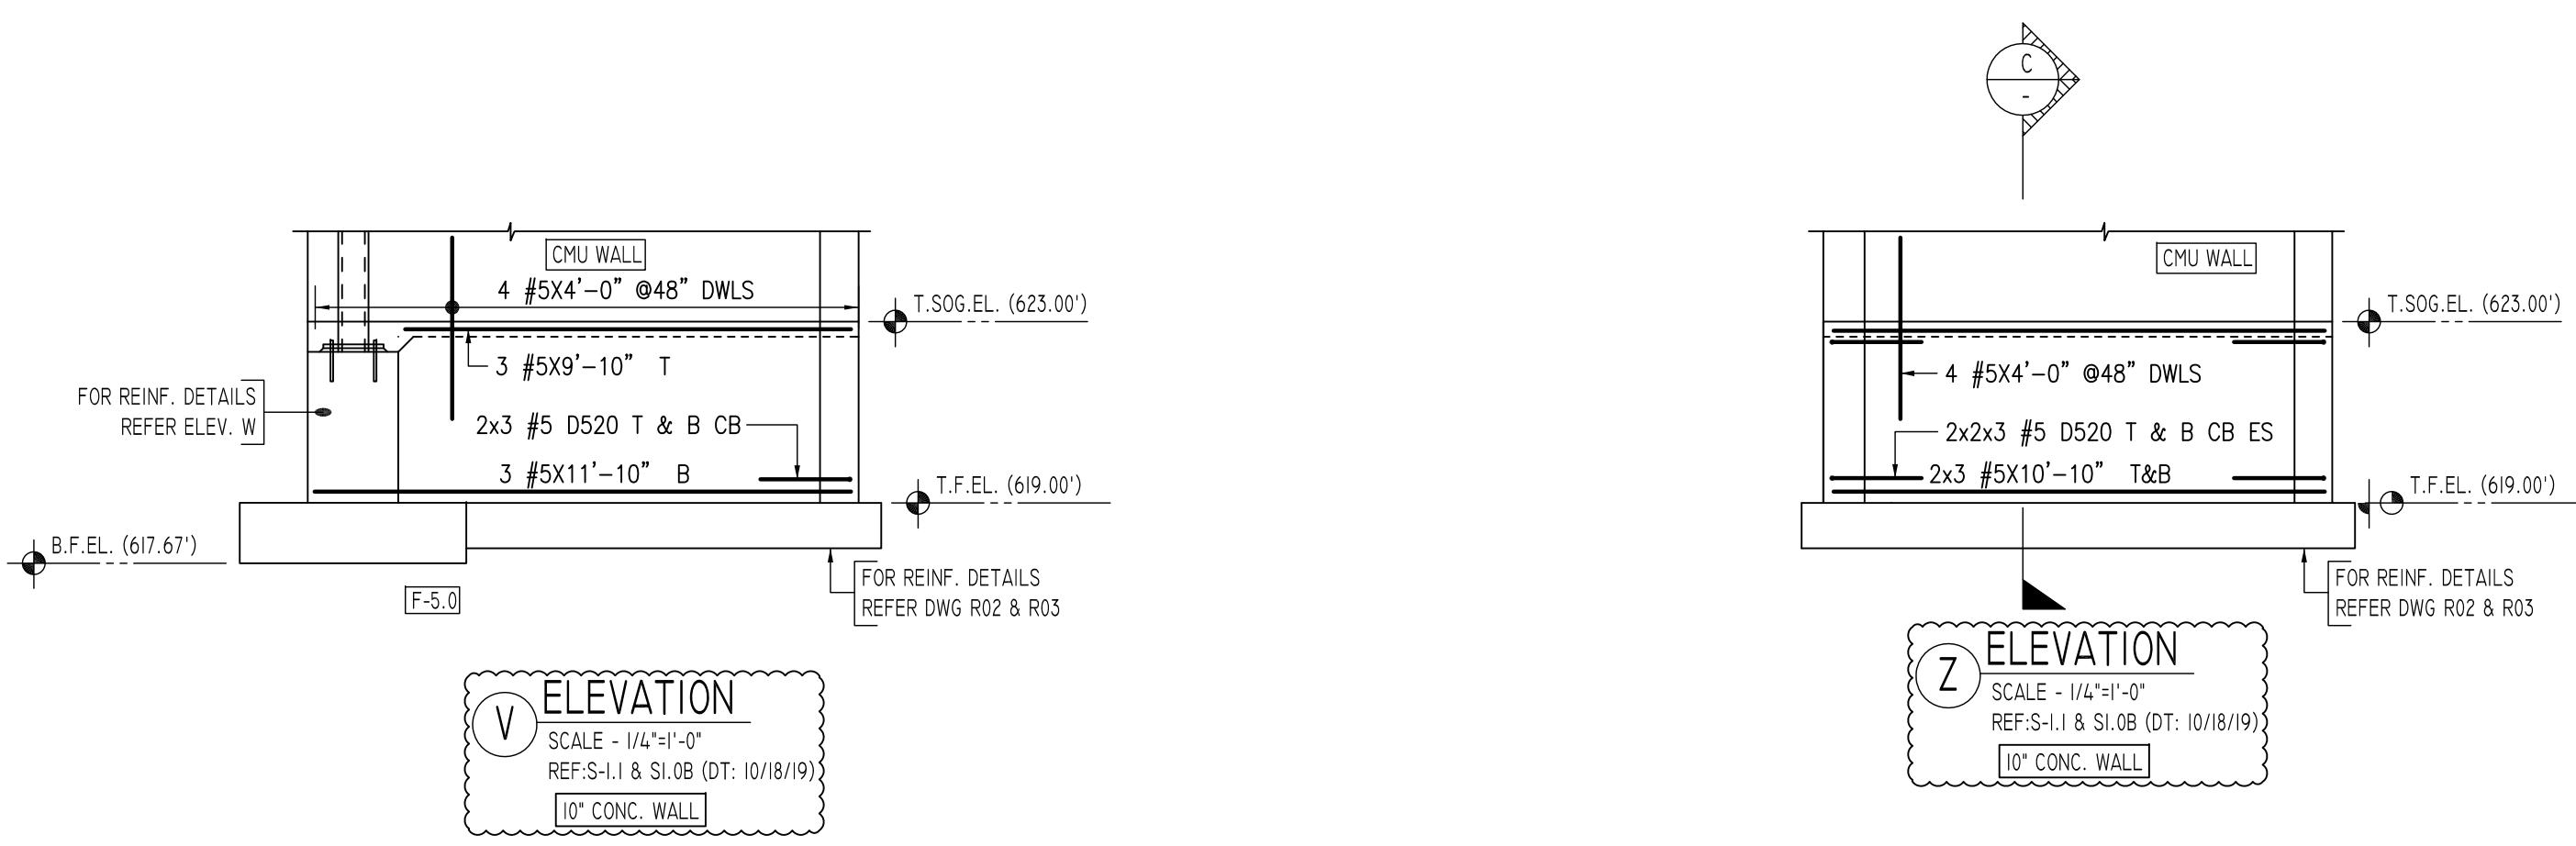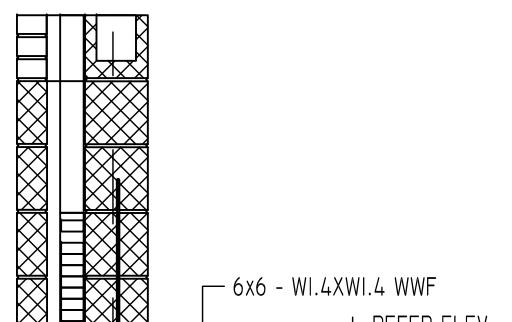


V ELEVATION
SCALE - 1/4"=1'-0"
REF:S-I.I & SI.0B (DT: 10/18/19)
10" CONC. WALL

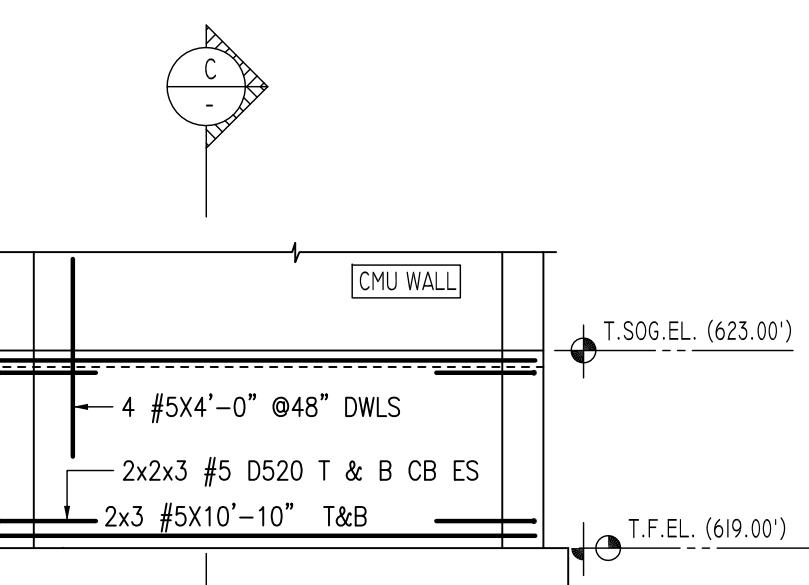

Z ELEVATION
SCALE - 1/4"=1'-0"
REF:S-1.1 & S1.0B (DT: 10/18/19)
10" CONC. WALL

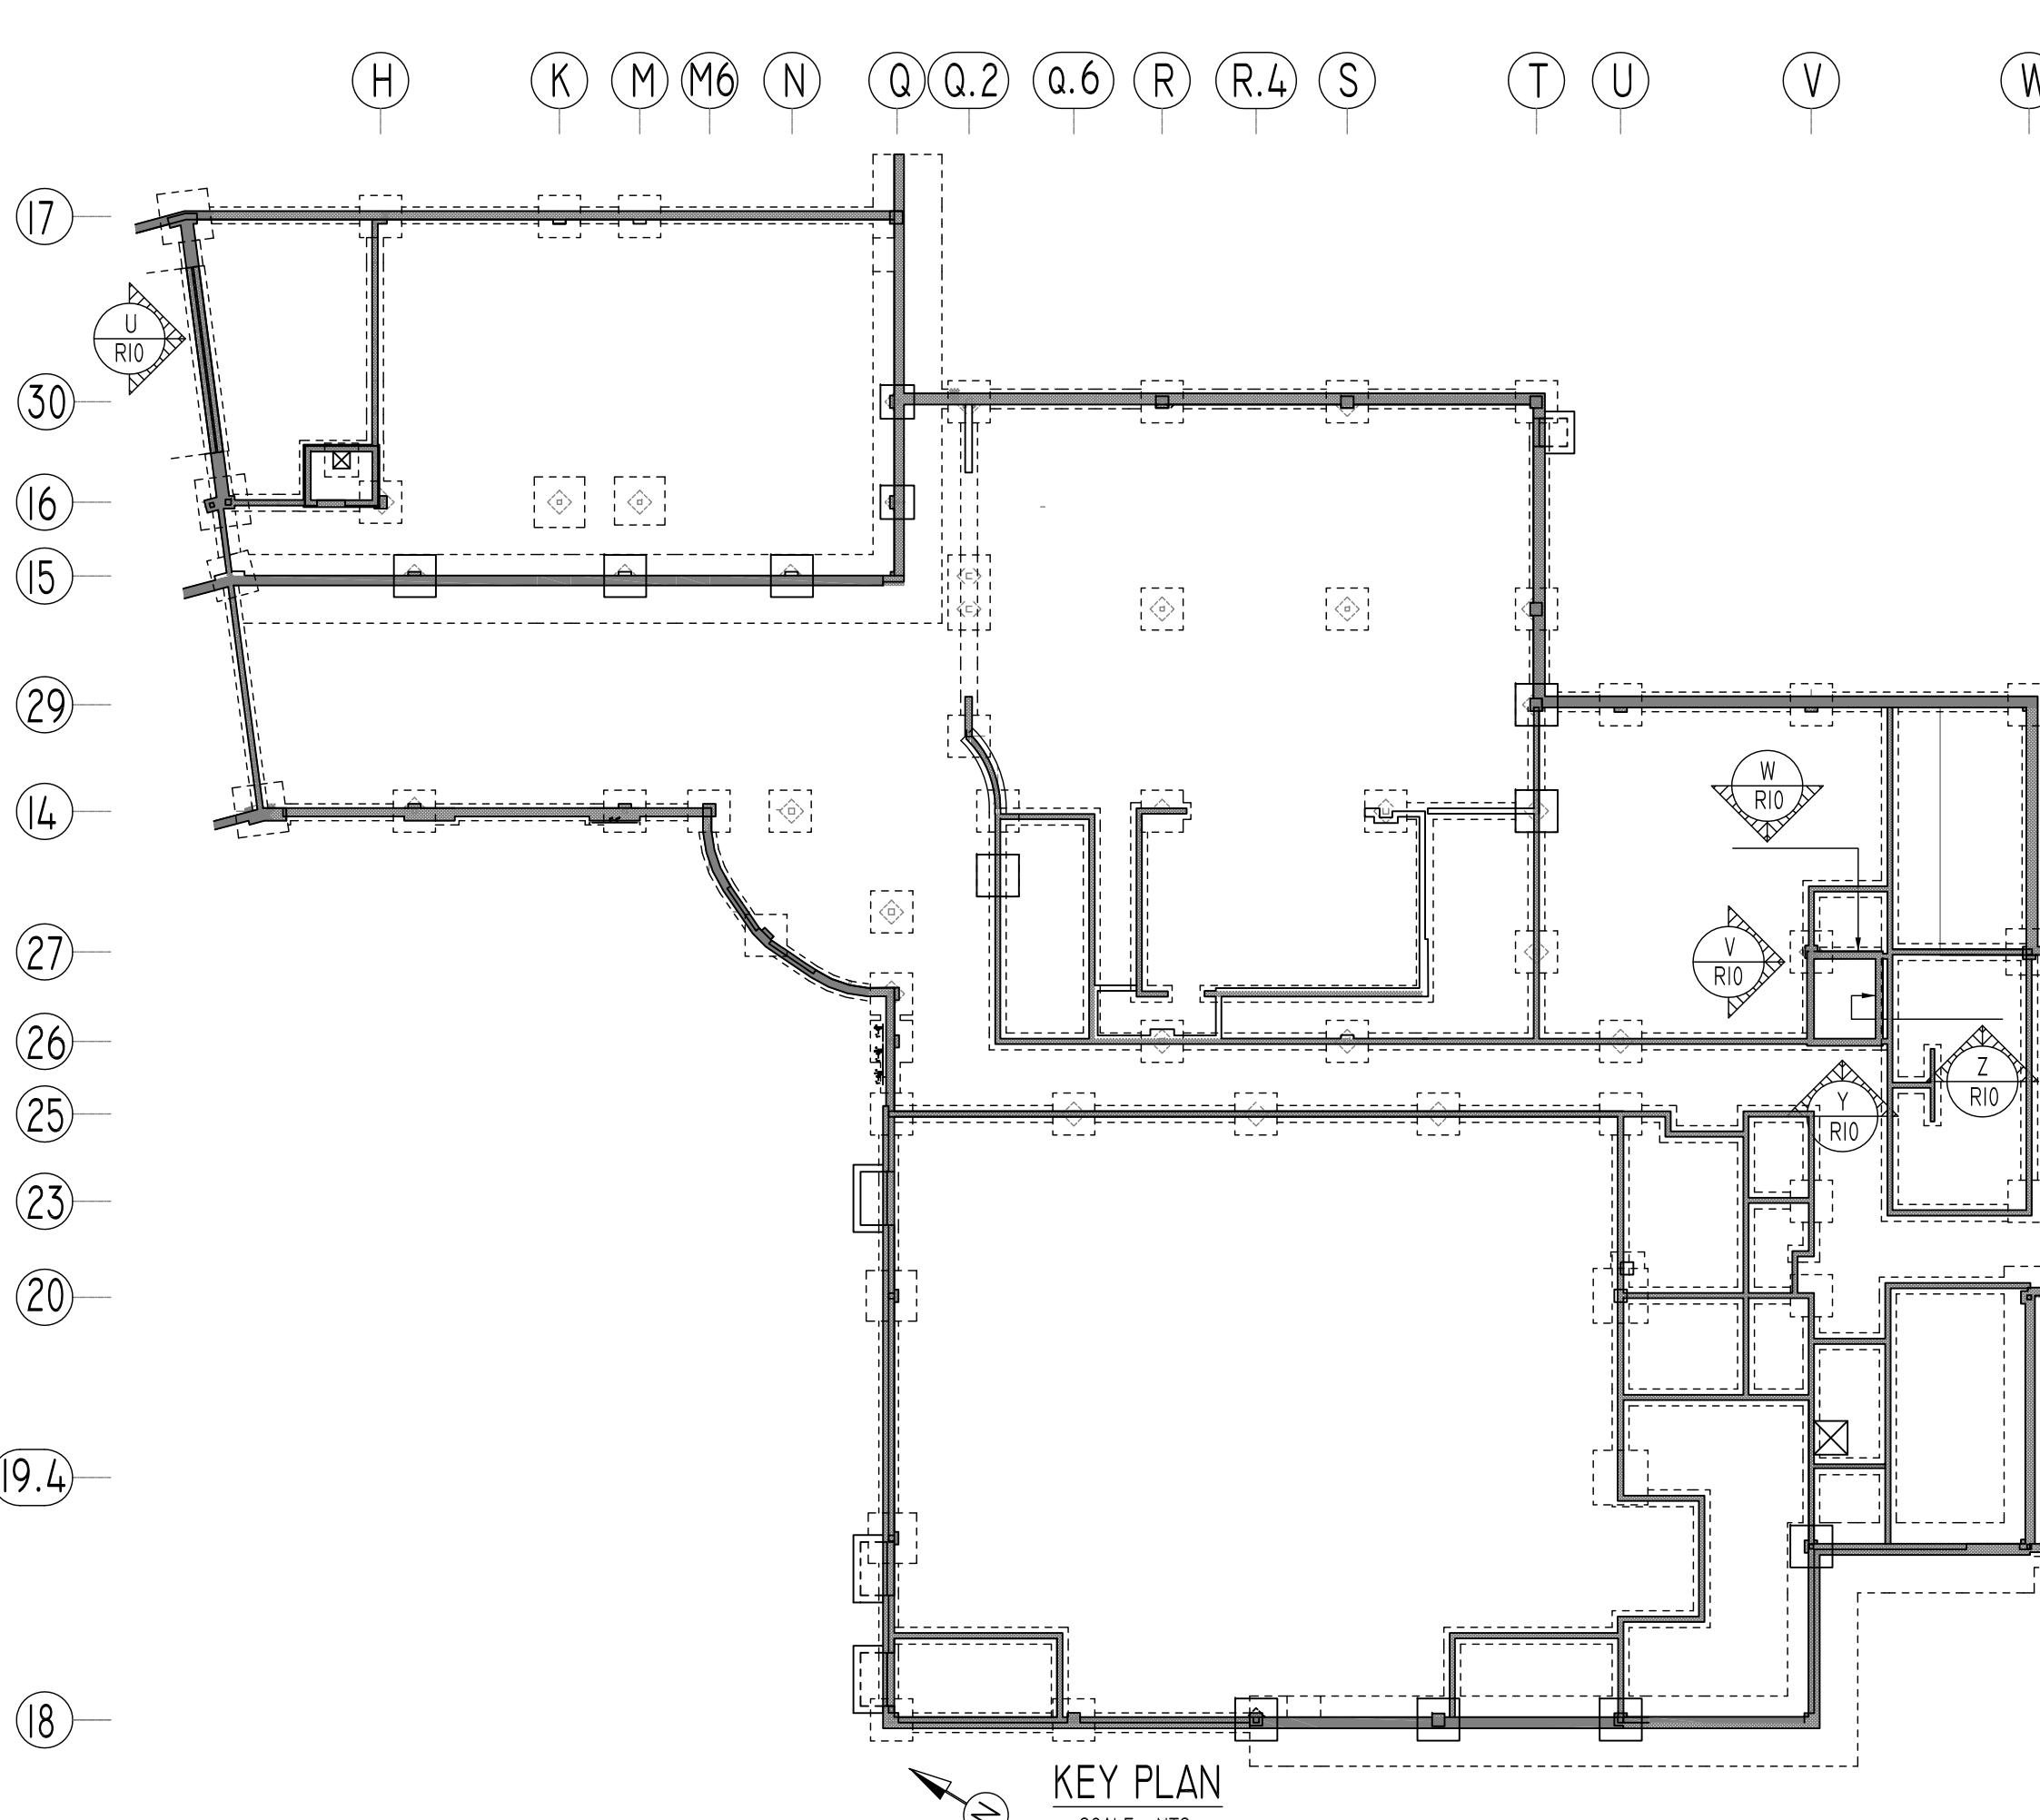

18

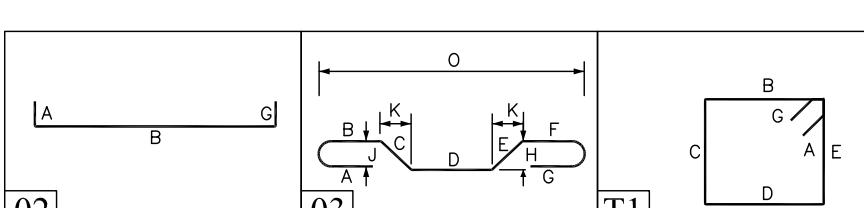

LAP SCHEDULE	
SIZE	36 X BD
	LAP
#4	18"
#5	23"
#6	27"
#7	32"

A/E PLEASE VERIFY
LAP VALUE (TYP.)

TYPICAL REINFORCING BAR CLEARANCE TABLE	
LOCATION	MIN. COVER
FOOTINGS AGAINST EARTH	3" CLR
COLUMNS AND PIERS (TIES. REINF.)	1 1/2" CLR
WALLS INTERIOR FACE	1 1/2" CLR
WALLS EXTERIOR FACE (#5 & SMALLER)	1 1/2" CLR
WALLS INTERIOR FACE (#6 & LARGER)	2" CLR
WALLS EXTERIOR FACE (#6 & LARGER)	2" CLR

AL

ALL BARS IN THIS DRAWING
ASTM A615 GRADE 60
BLACK UNCOATED

<p>OPNG=Opening BAL: Balance BTW:Between CJ=Construction Joint CLR: CLEARANCE CMU= Concrete Masonry Unit CONT.=Continuous EA.=Each Elev.=Elevation EMB=Embedment SW = Short Way LW=Long Way (BL)=Black Bar (EP)=Epoxy Bar (GA)= Galvanized</p>	<h2 style="text-align: center;"><u>NOTICE</u></h2> <p>Shortages, improper fabrication or claims for any other reason must be reported to this company within a periodof 15 days of delivery. This company reserves the right to field inspect prior to replacement or reconditioning of nonconforming material, and will not honor charges for work done in the field without specific authorization from this company.</p> <p>REINFORCING STEEL PLACING DRAWINGS ONLY USE IN CONJUNCTION WITH CONTRACT DRAWINGS & SPECIFICATIONS. ELEVATIONS & DIMENSIONS SHOWN ON THIS DRAWING ARE FOR DETAILING PURPOSES ONLY AND SHOULD NOT BE USED FOR CONSTRUCTION UNLESS VERIFIED BY ENGINEER OR CONTRACTOR.</p>
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REVISION MARK	REVISION DETAILS	DATE
0	FOR APPROVAL	02/18/2020

[View Details](#) | [Edit](#) | [Delete](#)






WENDELL CROSS ELEMENTARY SCHOOL

WENDELL CROSS ELEMENTARY SCHOOL
WATERBURY, CONNECTICUT

SZEWCZAK ASSOCIATES

G&G CONCRETE		DATE:	REVIEWED BY:	JOB NO.
RS	02/18/20	T/A		20009



RS	02/18/20	1/E	Z0003
SEA-A FOUNDATION WALL			DRAWING NO.: B10

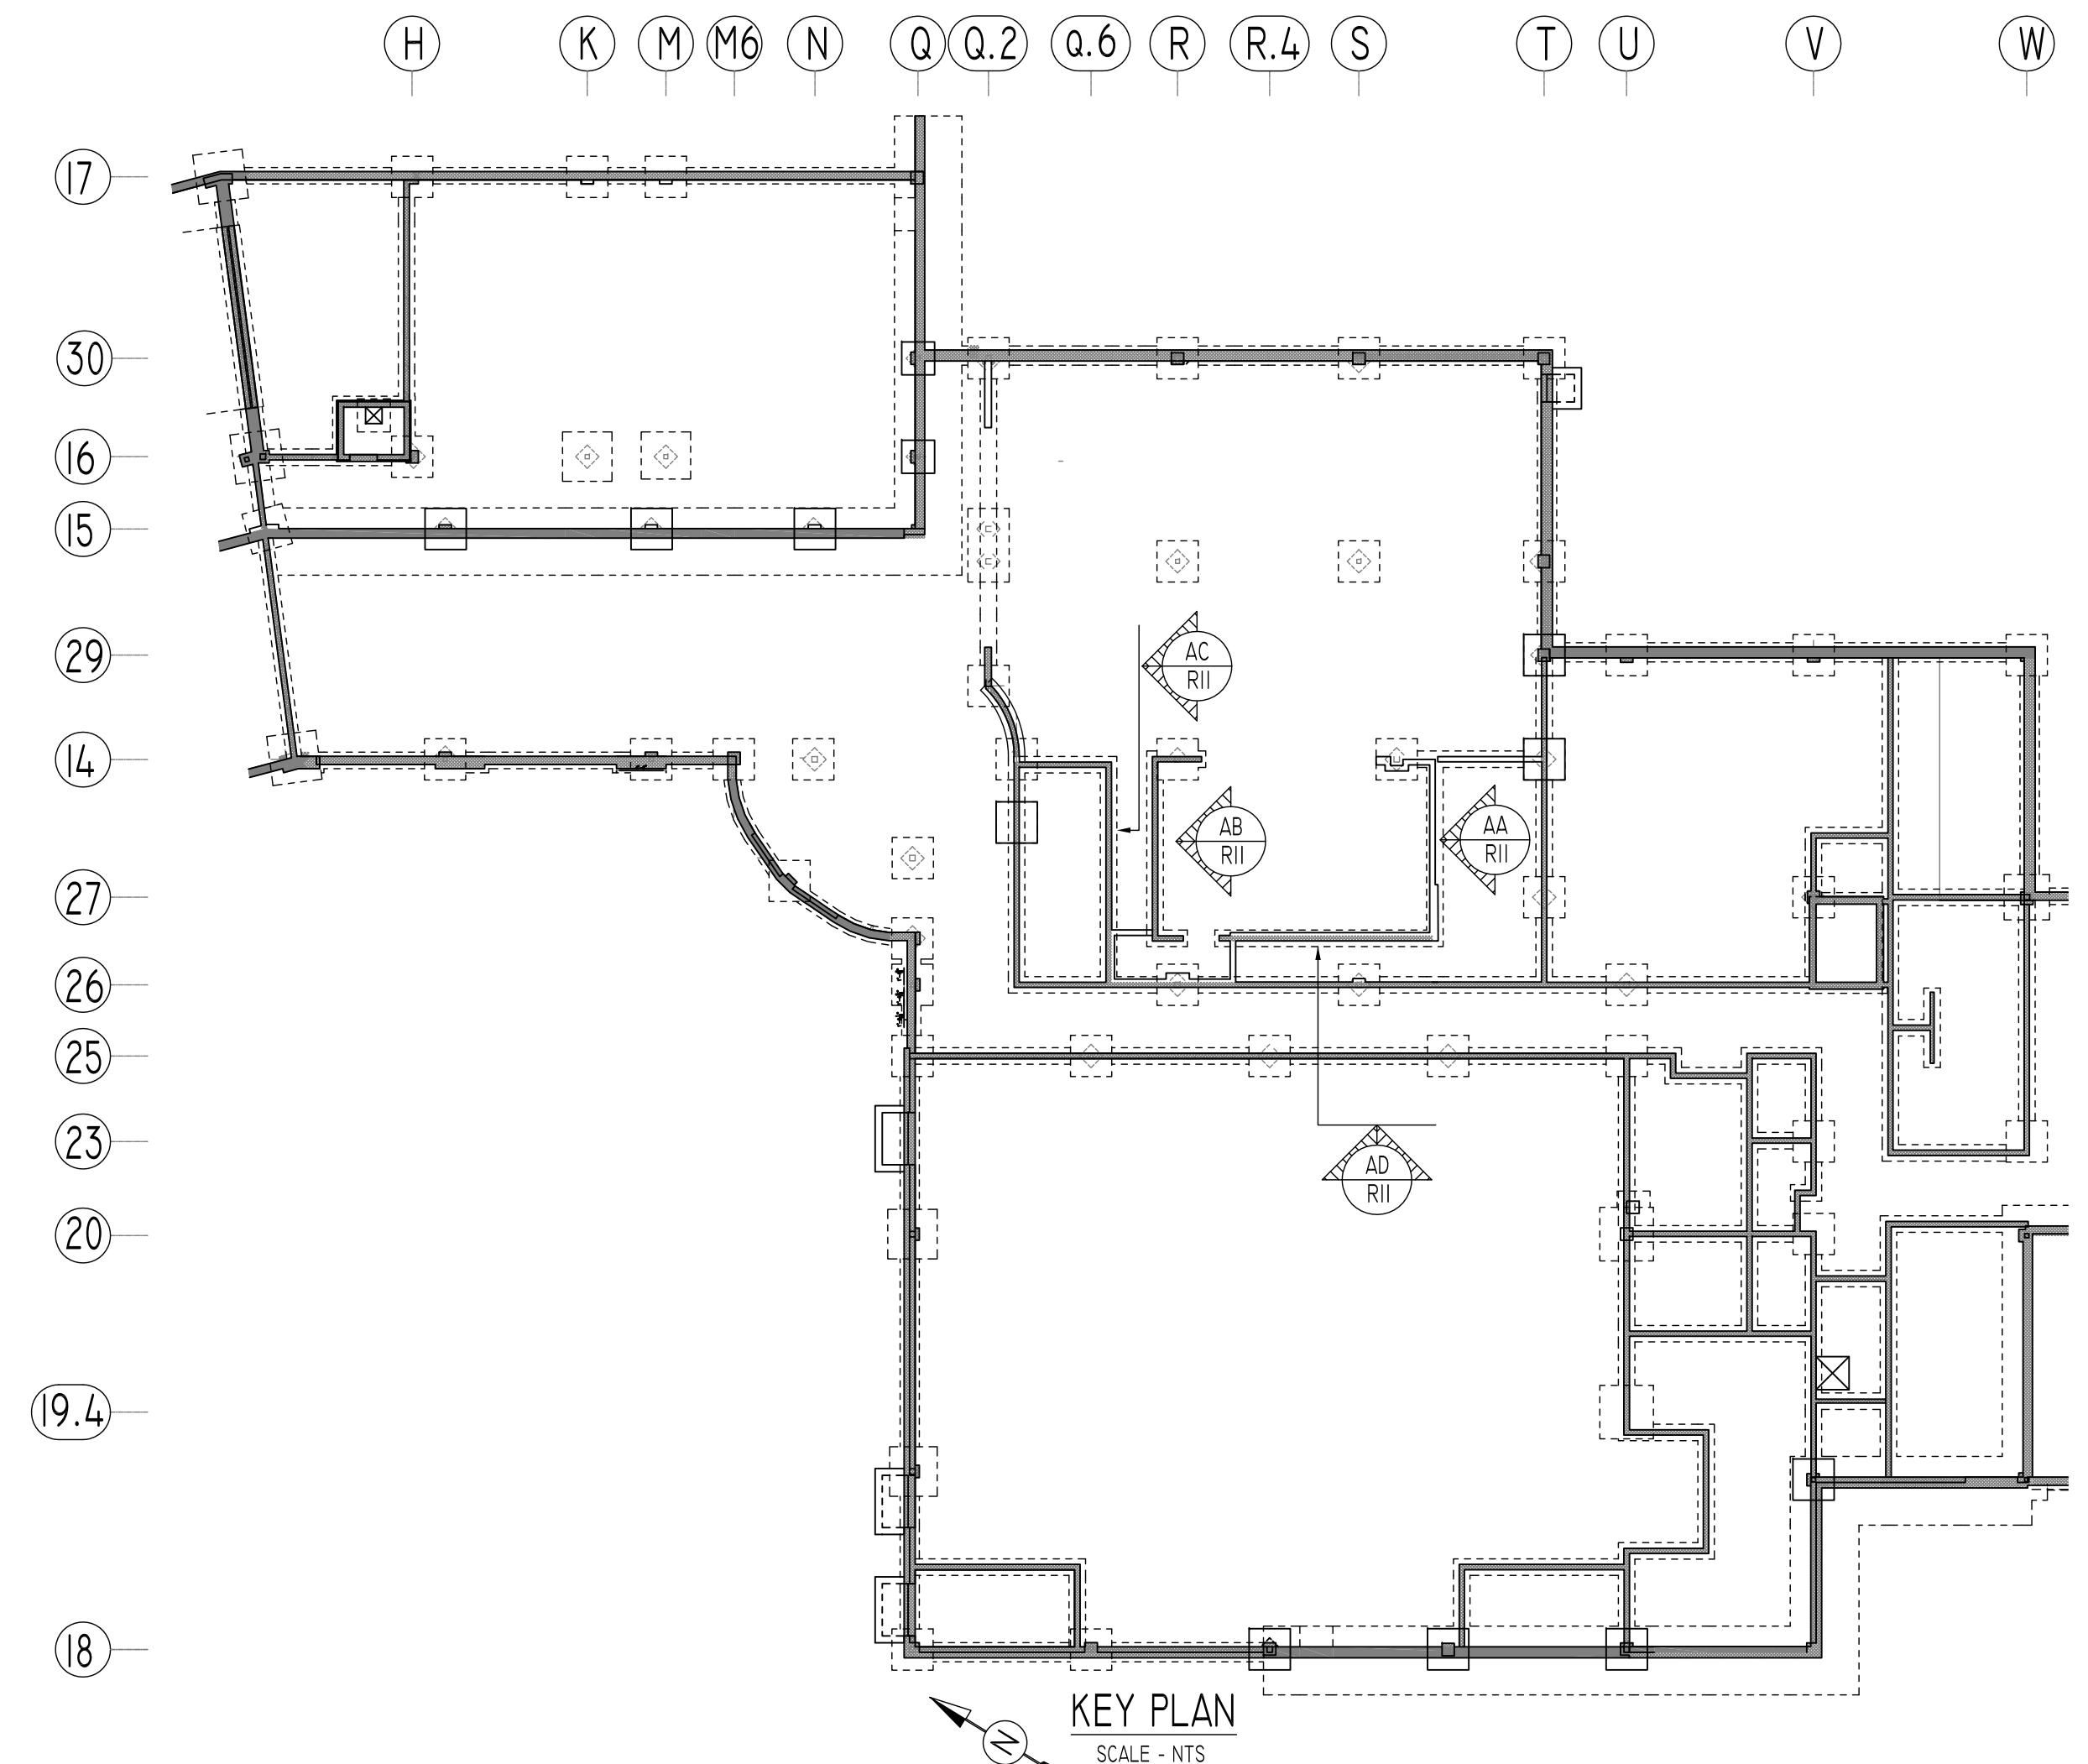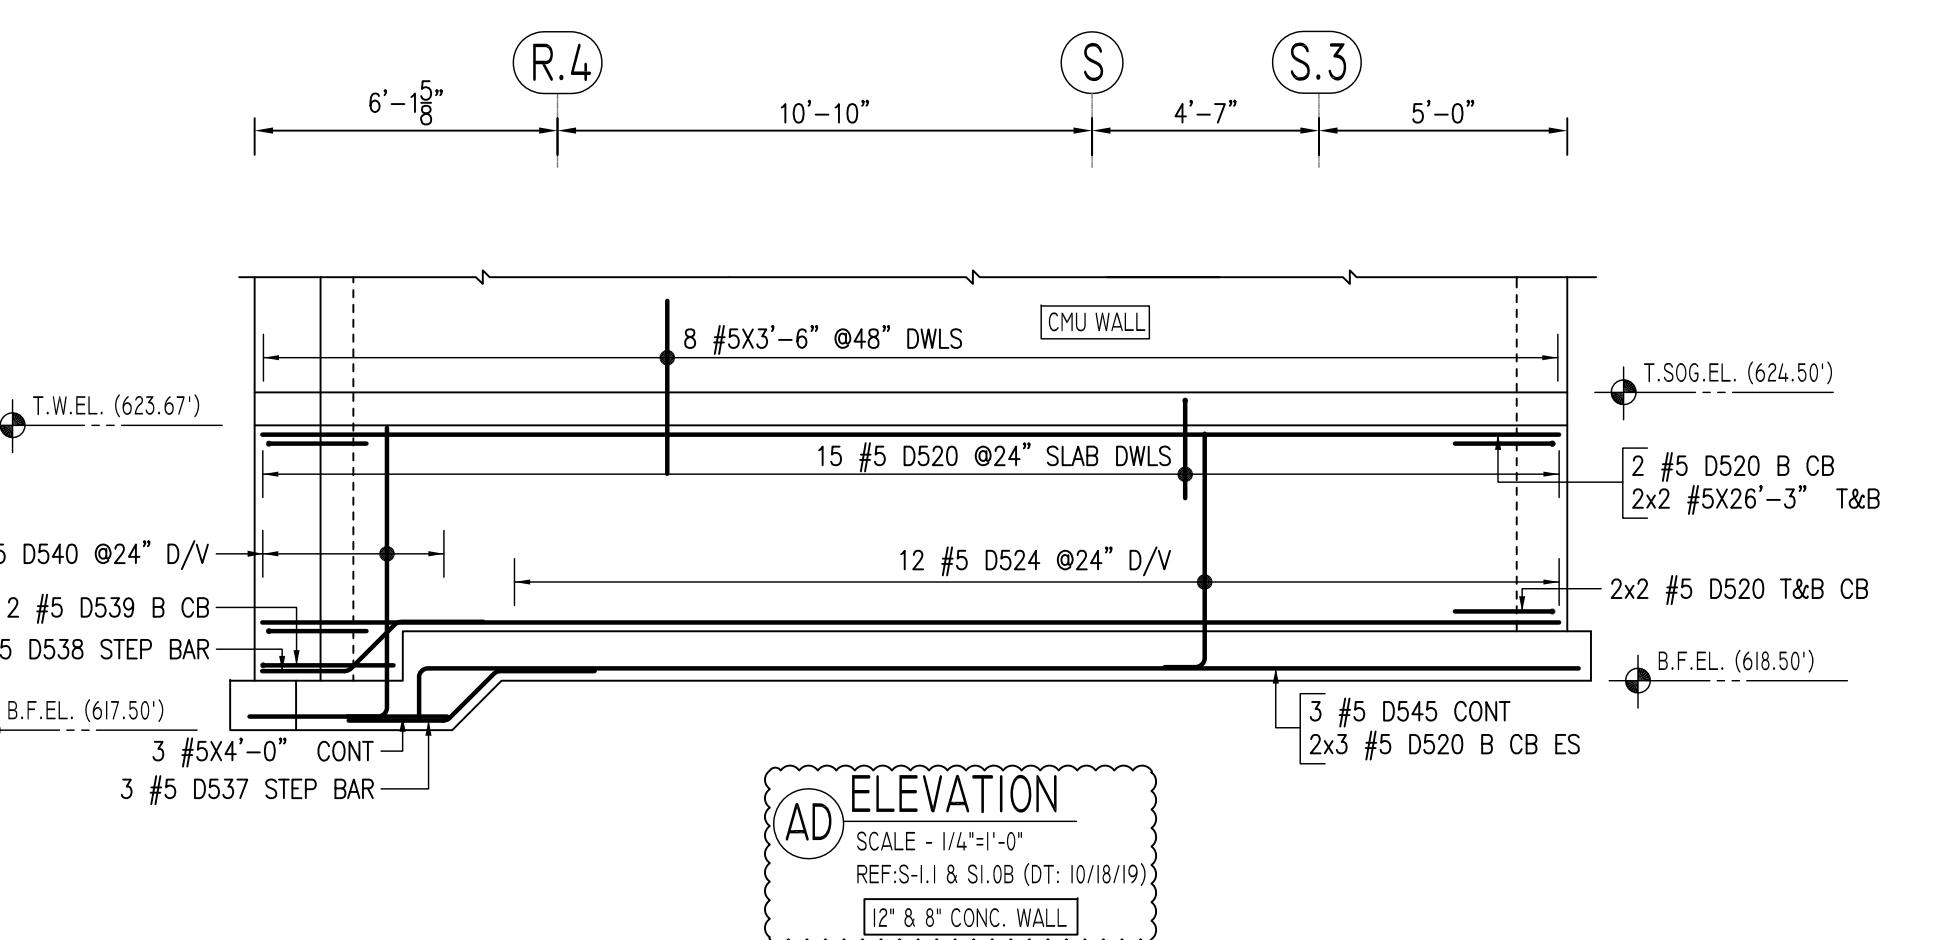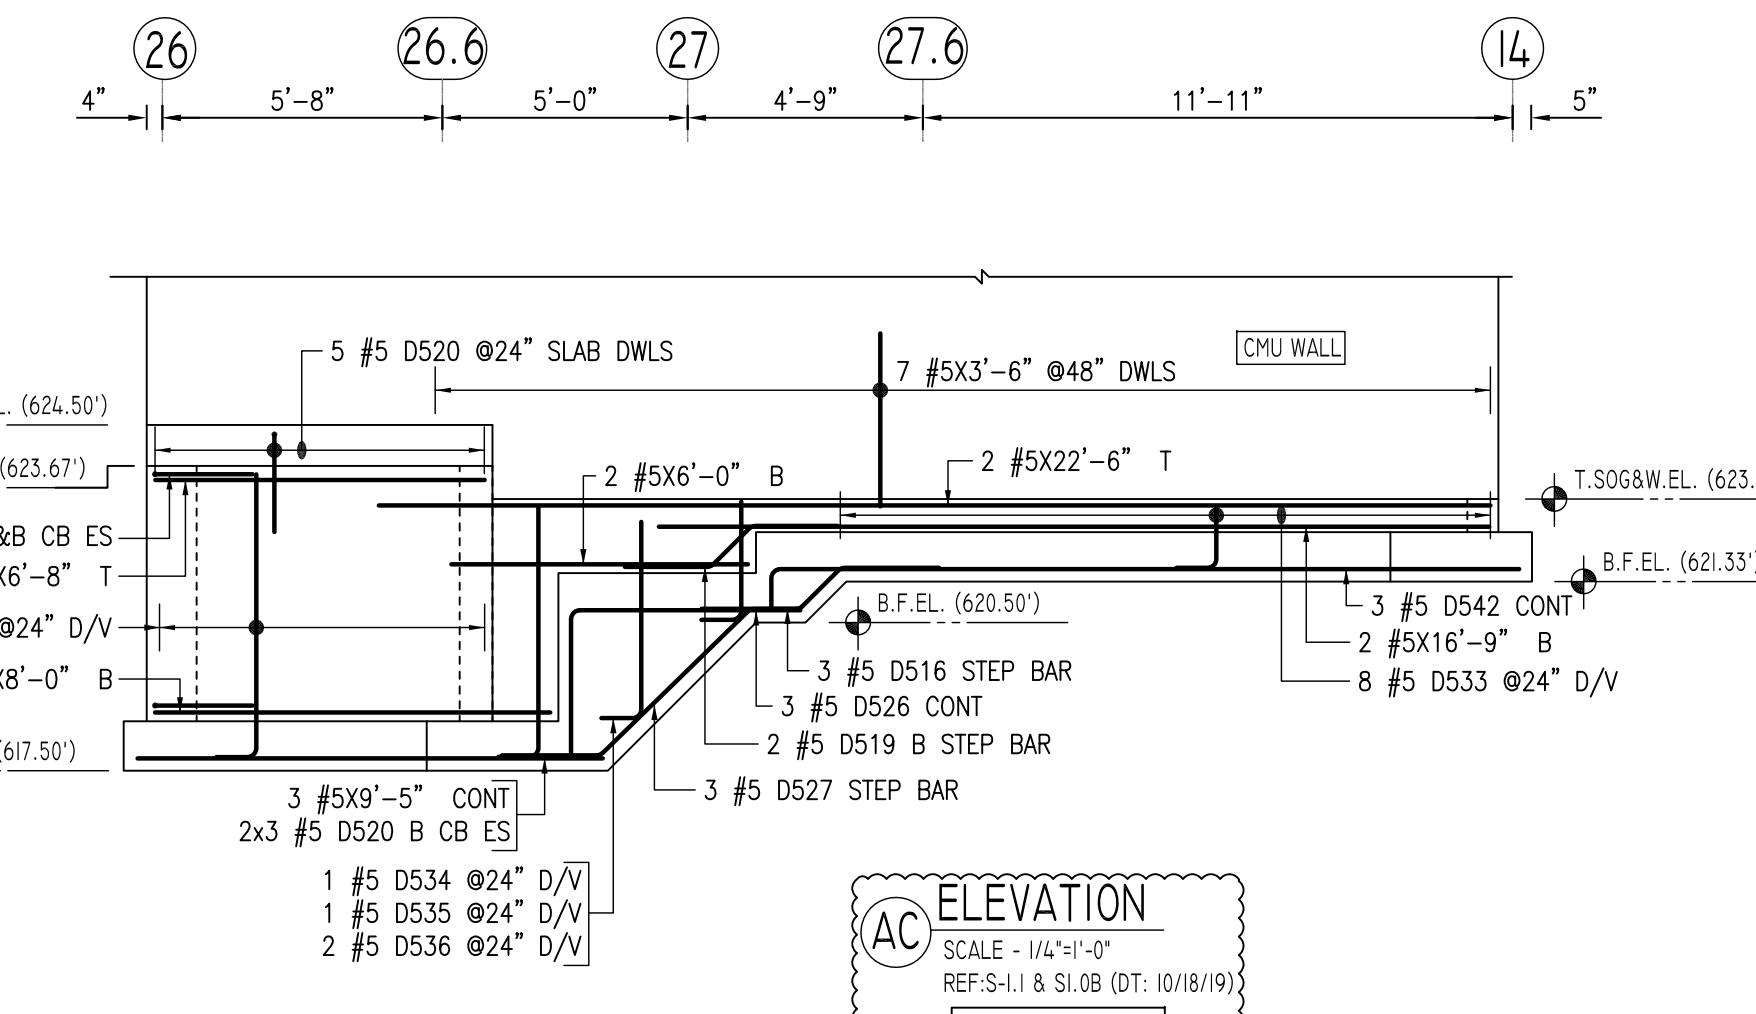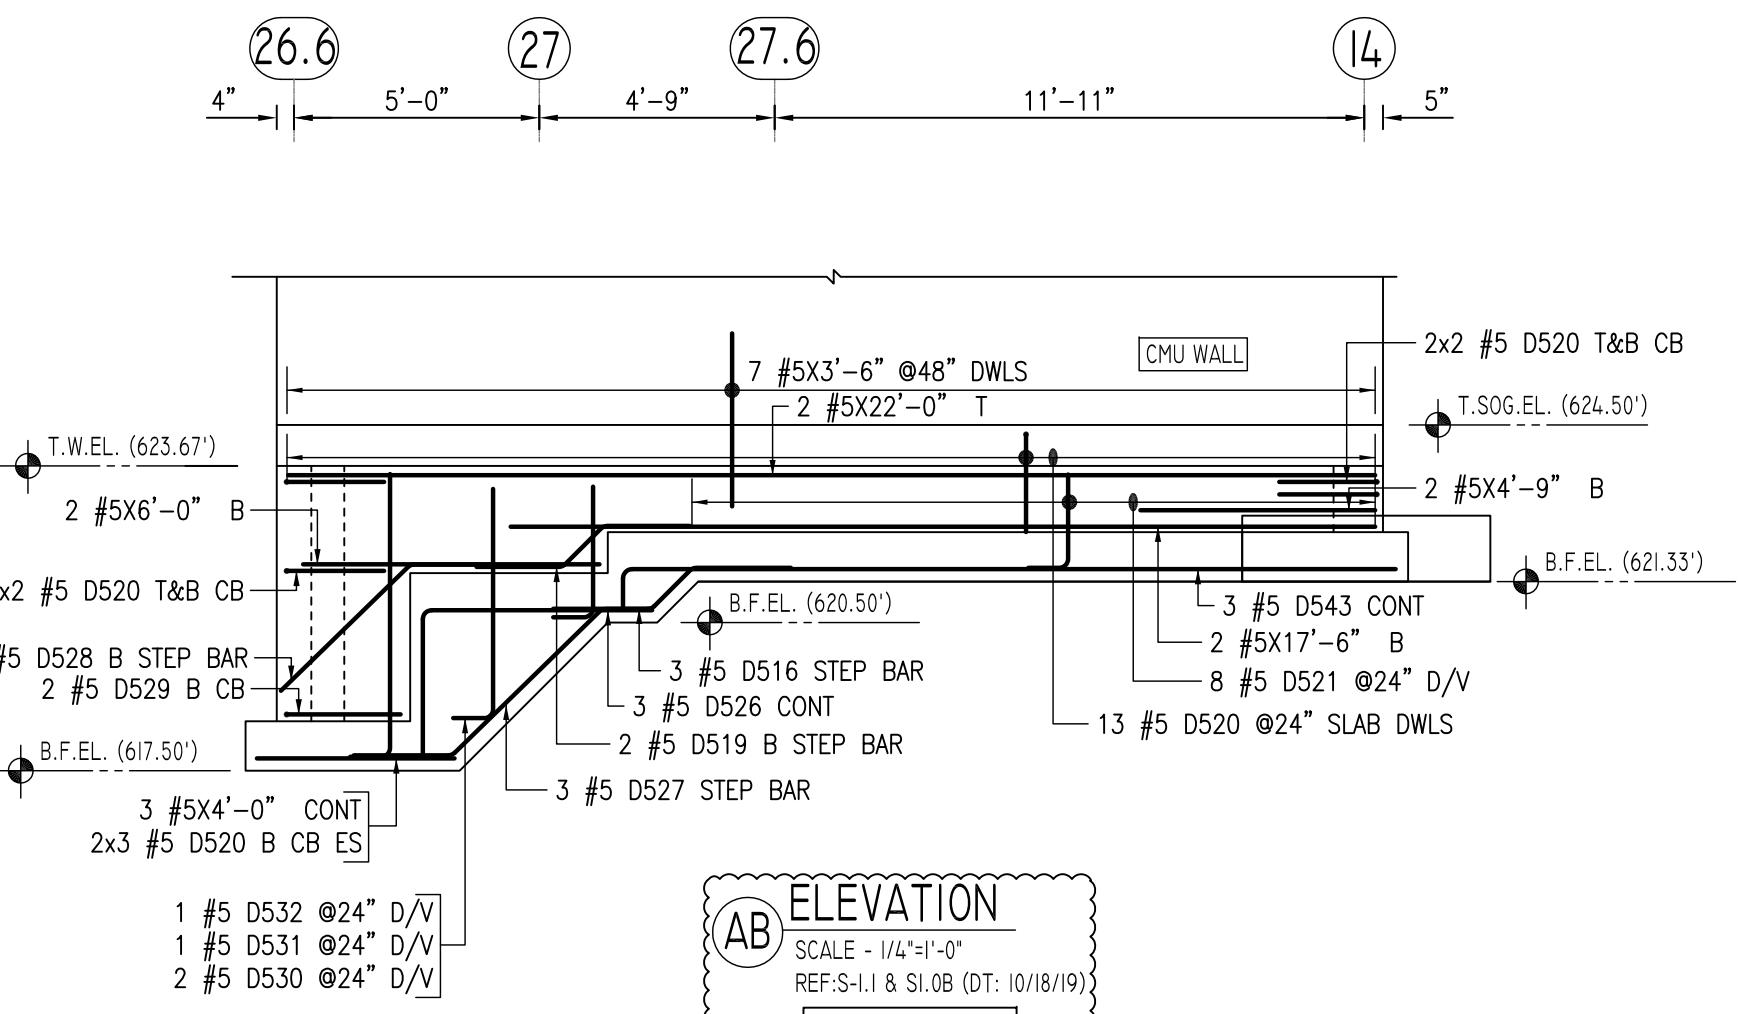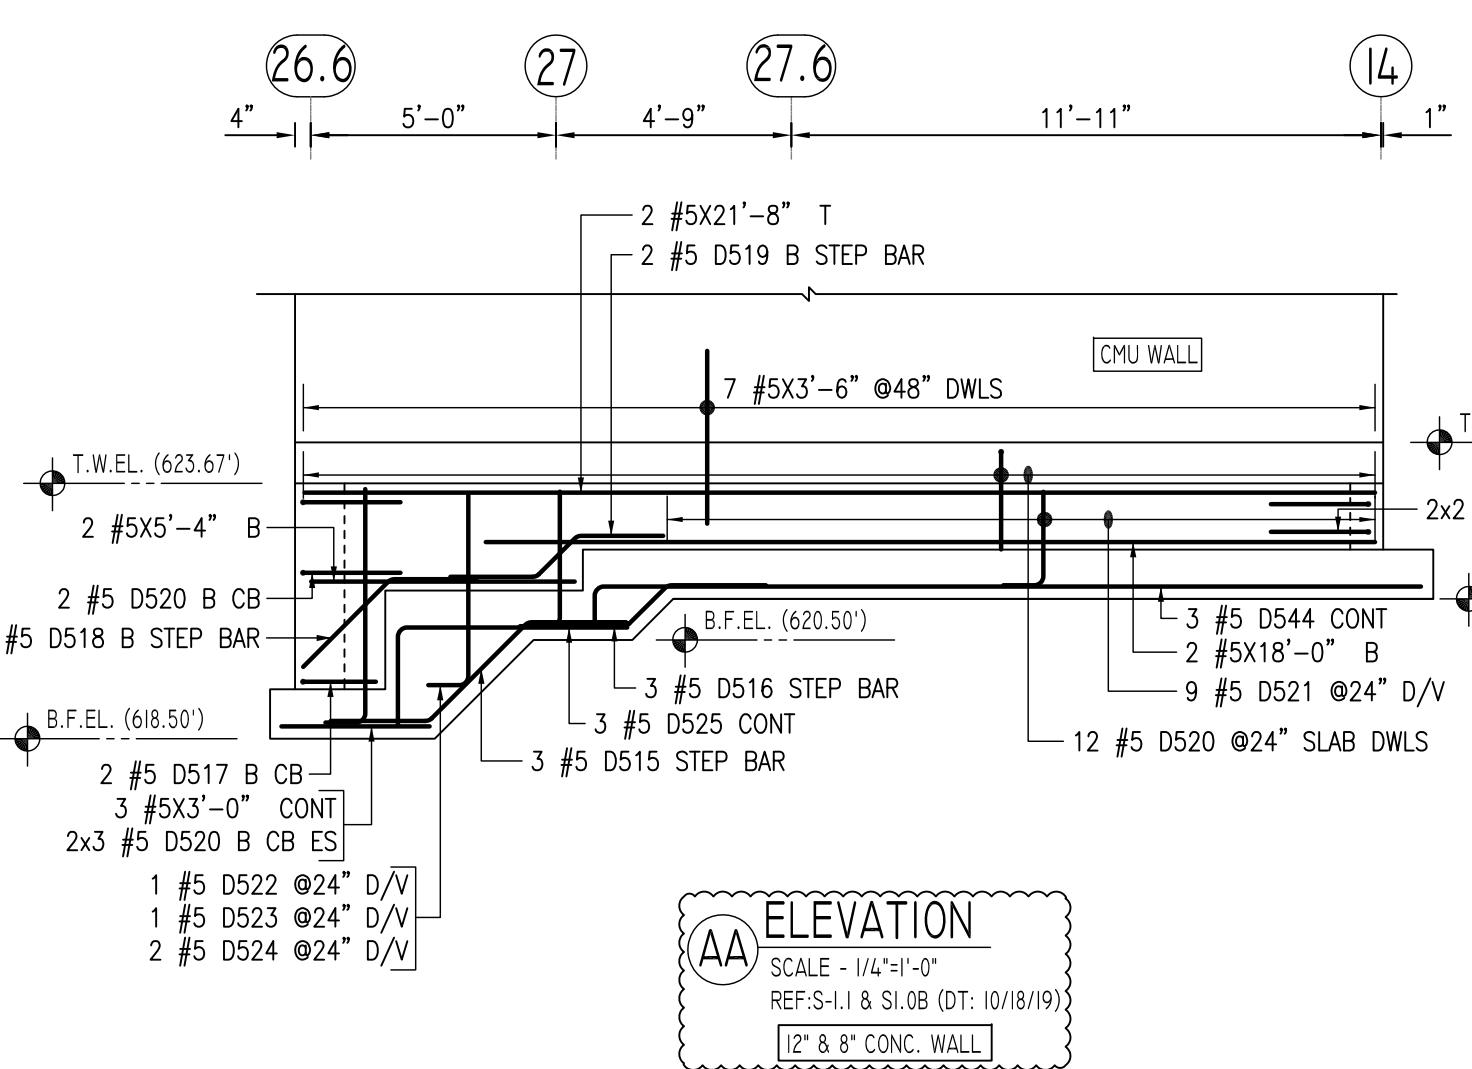


BENDING DETAILS.																	
Bar Mark	Qty	Size	Total length	Type	'A'	'B'	'C'	'D'	'E'	'F'	'G'	'H'	'I'	'J'	'K'	'L'	'R'
0515	3	#5	6'10" 3"		20"	210"	20"					20 1/2"		11 1/2"	5 1/2"		
0516	9	#5	52 1/2" 3"		20"	12 1/2"	20"					10 1/2"		9 1/2"	4 9/16"		
0517	2	#5	36" 17"		16"	20"											
0518	2	#5	4'3" 3"		19"	26"					19 1/2"		19 1/2"	36 1/4"			
0519	6	#5	4'8 1/2" 3"		19"	12 1/2"	19"				10 1/2"		9 1/2"	4 3/8"			
0520	97	#5	4'0" 17"		20"	20"											
0521	17	#5	2'9" 2"		10"	11"											
0522	1	#5	3'7" 2"		10"	29"											
0523	1	#5	4'9" 2"		10"	31"											
0524	14	#5	5'7" 2"		10"	4 9/16"											
0525	3	#5	6'8" 17"		20"	48"											
0526	6	#5	7'8" 17"		30"	48"											
0527	6	#5	72 1/2" 3"		11 1/2"	43"	11 1/2"				30"		30"	60"			
0528	2	#5	55" 3"		19"	38"					27"		27 1/2"	44 1/4"			
0529	2	#5	4'4" 17"		20"	24"											
0530	7	#5	6'7" 2"		10"	59"											
0531	1	#5	5'6" 2"		10"	4 8/16"											
0532	1	#5	3'6" 2"		10"	28"											
0533	8	#5	2'1" 2"		10"	13"											
0534	1	#5	3'3" 2"		10"	25"											
0535	1	#5	4'10" 2"		10"	40"											
0536	2	#5	5'11" 2"		10"	51"											
0537	3	#5	5'5" 1/2" 3"		20"	15 1/2"	20"				10 1/2"		11 1/2"	4 11 1/2"			
0538	2	#5	4'11 1/2" 3"		19"	15 1/2"	19"				10 1/2"		11 1/2"	4 5/8"			
0539	2	#5	4'8" 17"		20"	28"											
0540	3	#5	6'8 1/2" 2"		10"	51 1/2"											
0542	3	#5	16'0" 2"		10"	152"											
0543	3	#5	16'6" 2"		10"	158"											
0544	3	#5	17'7" 2"		10"	153"					236"						
0545	3	#5	24'6" 17"		10"												

LAP SCHEDULE	

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BENDING DETAILS.																
Bor. Mark	Qty	Size	Total length	Type	'A'	'B'	'C'	'D'	'E'	'F'	'G'	'H'	'I'	'K'	'O'	'R'
D301	38	#3	5'8" 11"	4"	13"	13"	13"	13"	13"	4"	2 1/2"					
D501	3	#5	5'4 1/2" 3"	10"	19"	110 1/2"	19"				14 1/2"		13 1/2"	49 1/2"		
D514	3	#5	4'6" 2"	10"	38"											
D515	6	#5	6'10" 3"		20"	2'10"	20"				20 1/2"		111 1/2"			
D517	2	#5	3'6" 17"		16"	20"										
D518	2	#5	4'3" 3"		19"	26"					19 1/2"		19 1/2"	36 1/2"		
D520	74	#5	4'0" 17"		20"	20"										
D521	1	#5	2'9" 2"		10"	110"										
D522	5	#5	3'7" 2"		10"	23"										
D523	3	#5	4'9" 2"		10"	31"										
D525	3	#5	6'8" 10"		20"	4'8"										
D526	1	#5	3'3" 2"		10"	25"										
D527	3	#5	5'5 1/2" 3"		20"	15 1/2"	20"				10 1/2"		11 1/2"	41 1/2"		
D541	11	#5	6'6" 2"		10"	58"										
D546	3	#5	6'9" 10"		14"	4'8"										
D547	3	#5	2'8" 10"		110"	28 0"										
D548	3	#5	4'3" 2"		10"	35"										
D549	3	#5	6'4" 3"		19"	2'10"	19"				20 1/2"		111 1/2"	55 1/2"		
D550	9	#5	2'10" 2"		10"	21"										
D551	5	#5	4'7" 2"		10"	39"										
D552	3	#5	4'8 1/2" 3"		20"	8 1/2"	20"				6 1/2"		5 1/2"	45 1/2"		
D553	3	#5	10'0" 17"		6"	10'6"										
D554	3	#5	8'3" 17"		10"	7'3"										
D703	8	#7	5'3" 2"		12"	4"										
D704	8	#7	5'9" 2"		12"	47"										

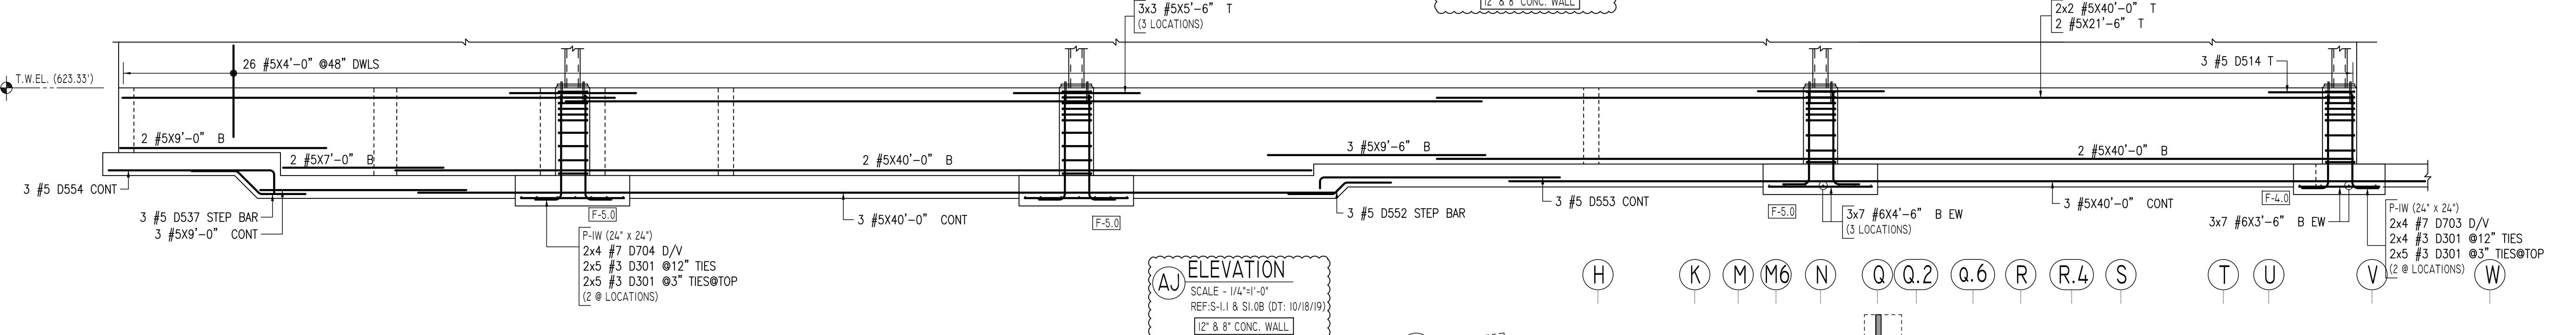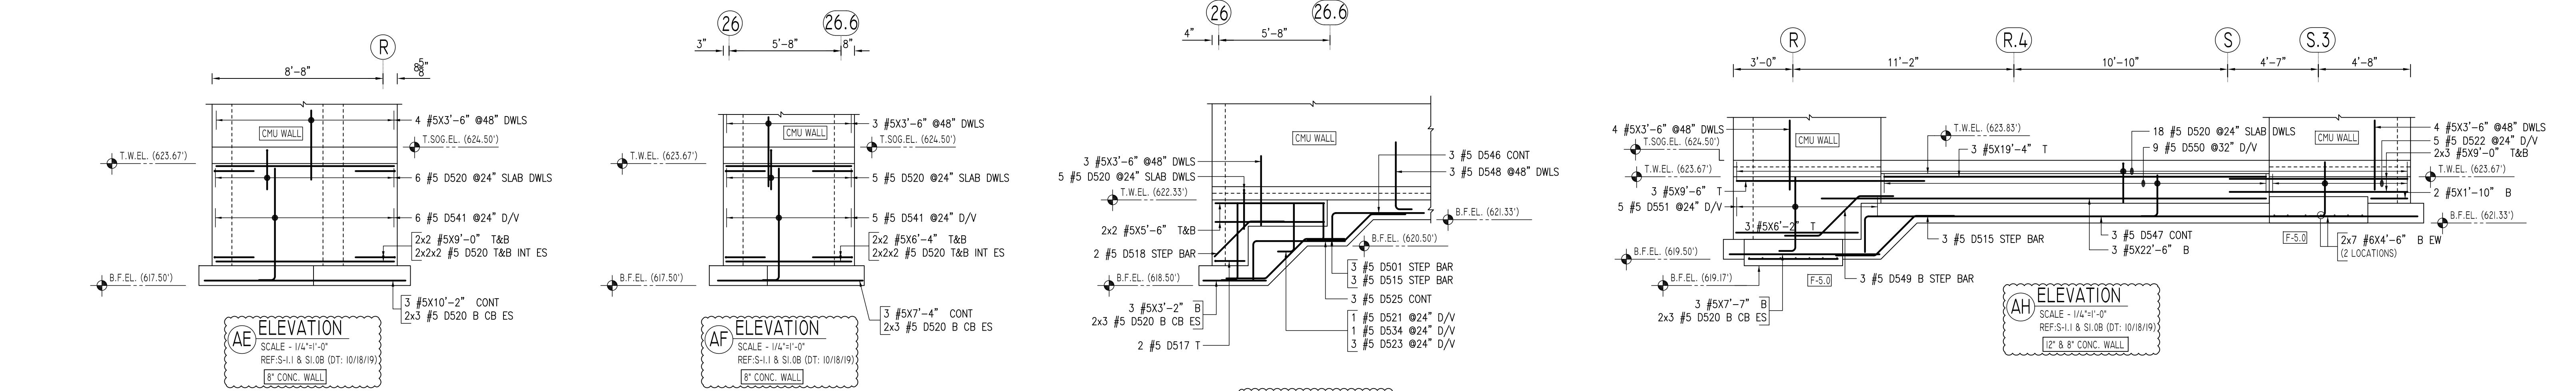


LAP SCHEDULE	
SIZE	36 X BD
LAP	
#4	18"
#5	23"
#6	27"
#7	32"

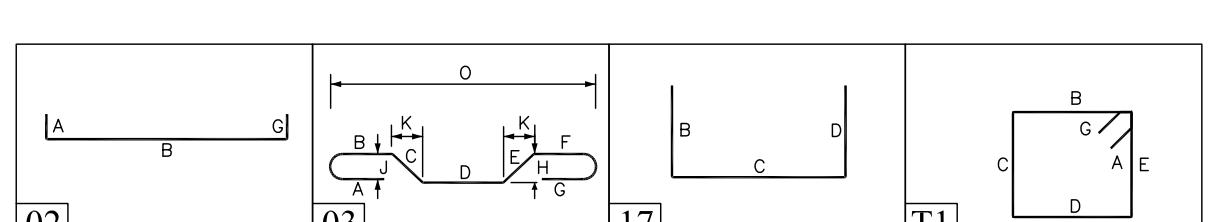A/E PLEASE VERIFY
LAP VALUE (TYP.)

TYPICAL REINFORCING BAR CLEARANCE TABLE	
LOCATION	MIN. COVER
FOOTINGS AGAINST EARTH	3" CLR
COLUMNS AND PIERS (TIES, REINF.)	1 1/2" CLR
WALLS INTERIOR FACE	1 1/2" CLR
WALLS EXTERIOR FACE (#5 & SMALLER)	1 1/2" CLR
WALLS INTERIOR FACE (#6 & LARGER)	2" CLR
WALLS EXTERIOR FACE (#6 & LARGER)	2" CLR

A/E PLEASE VERIFY
COVER VALUE (TYP.)

ALL BARS IN THIS DRAWING
ASTM A615 GRADE 60
BLACK UNCOATED


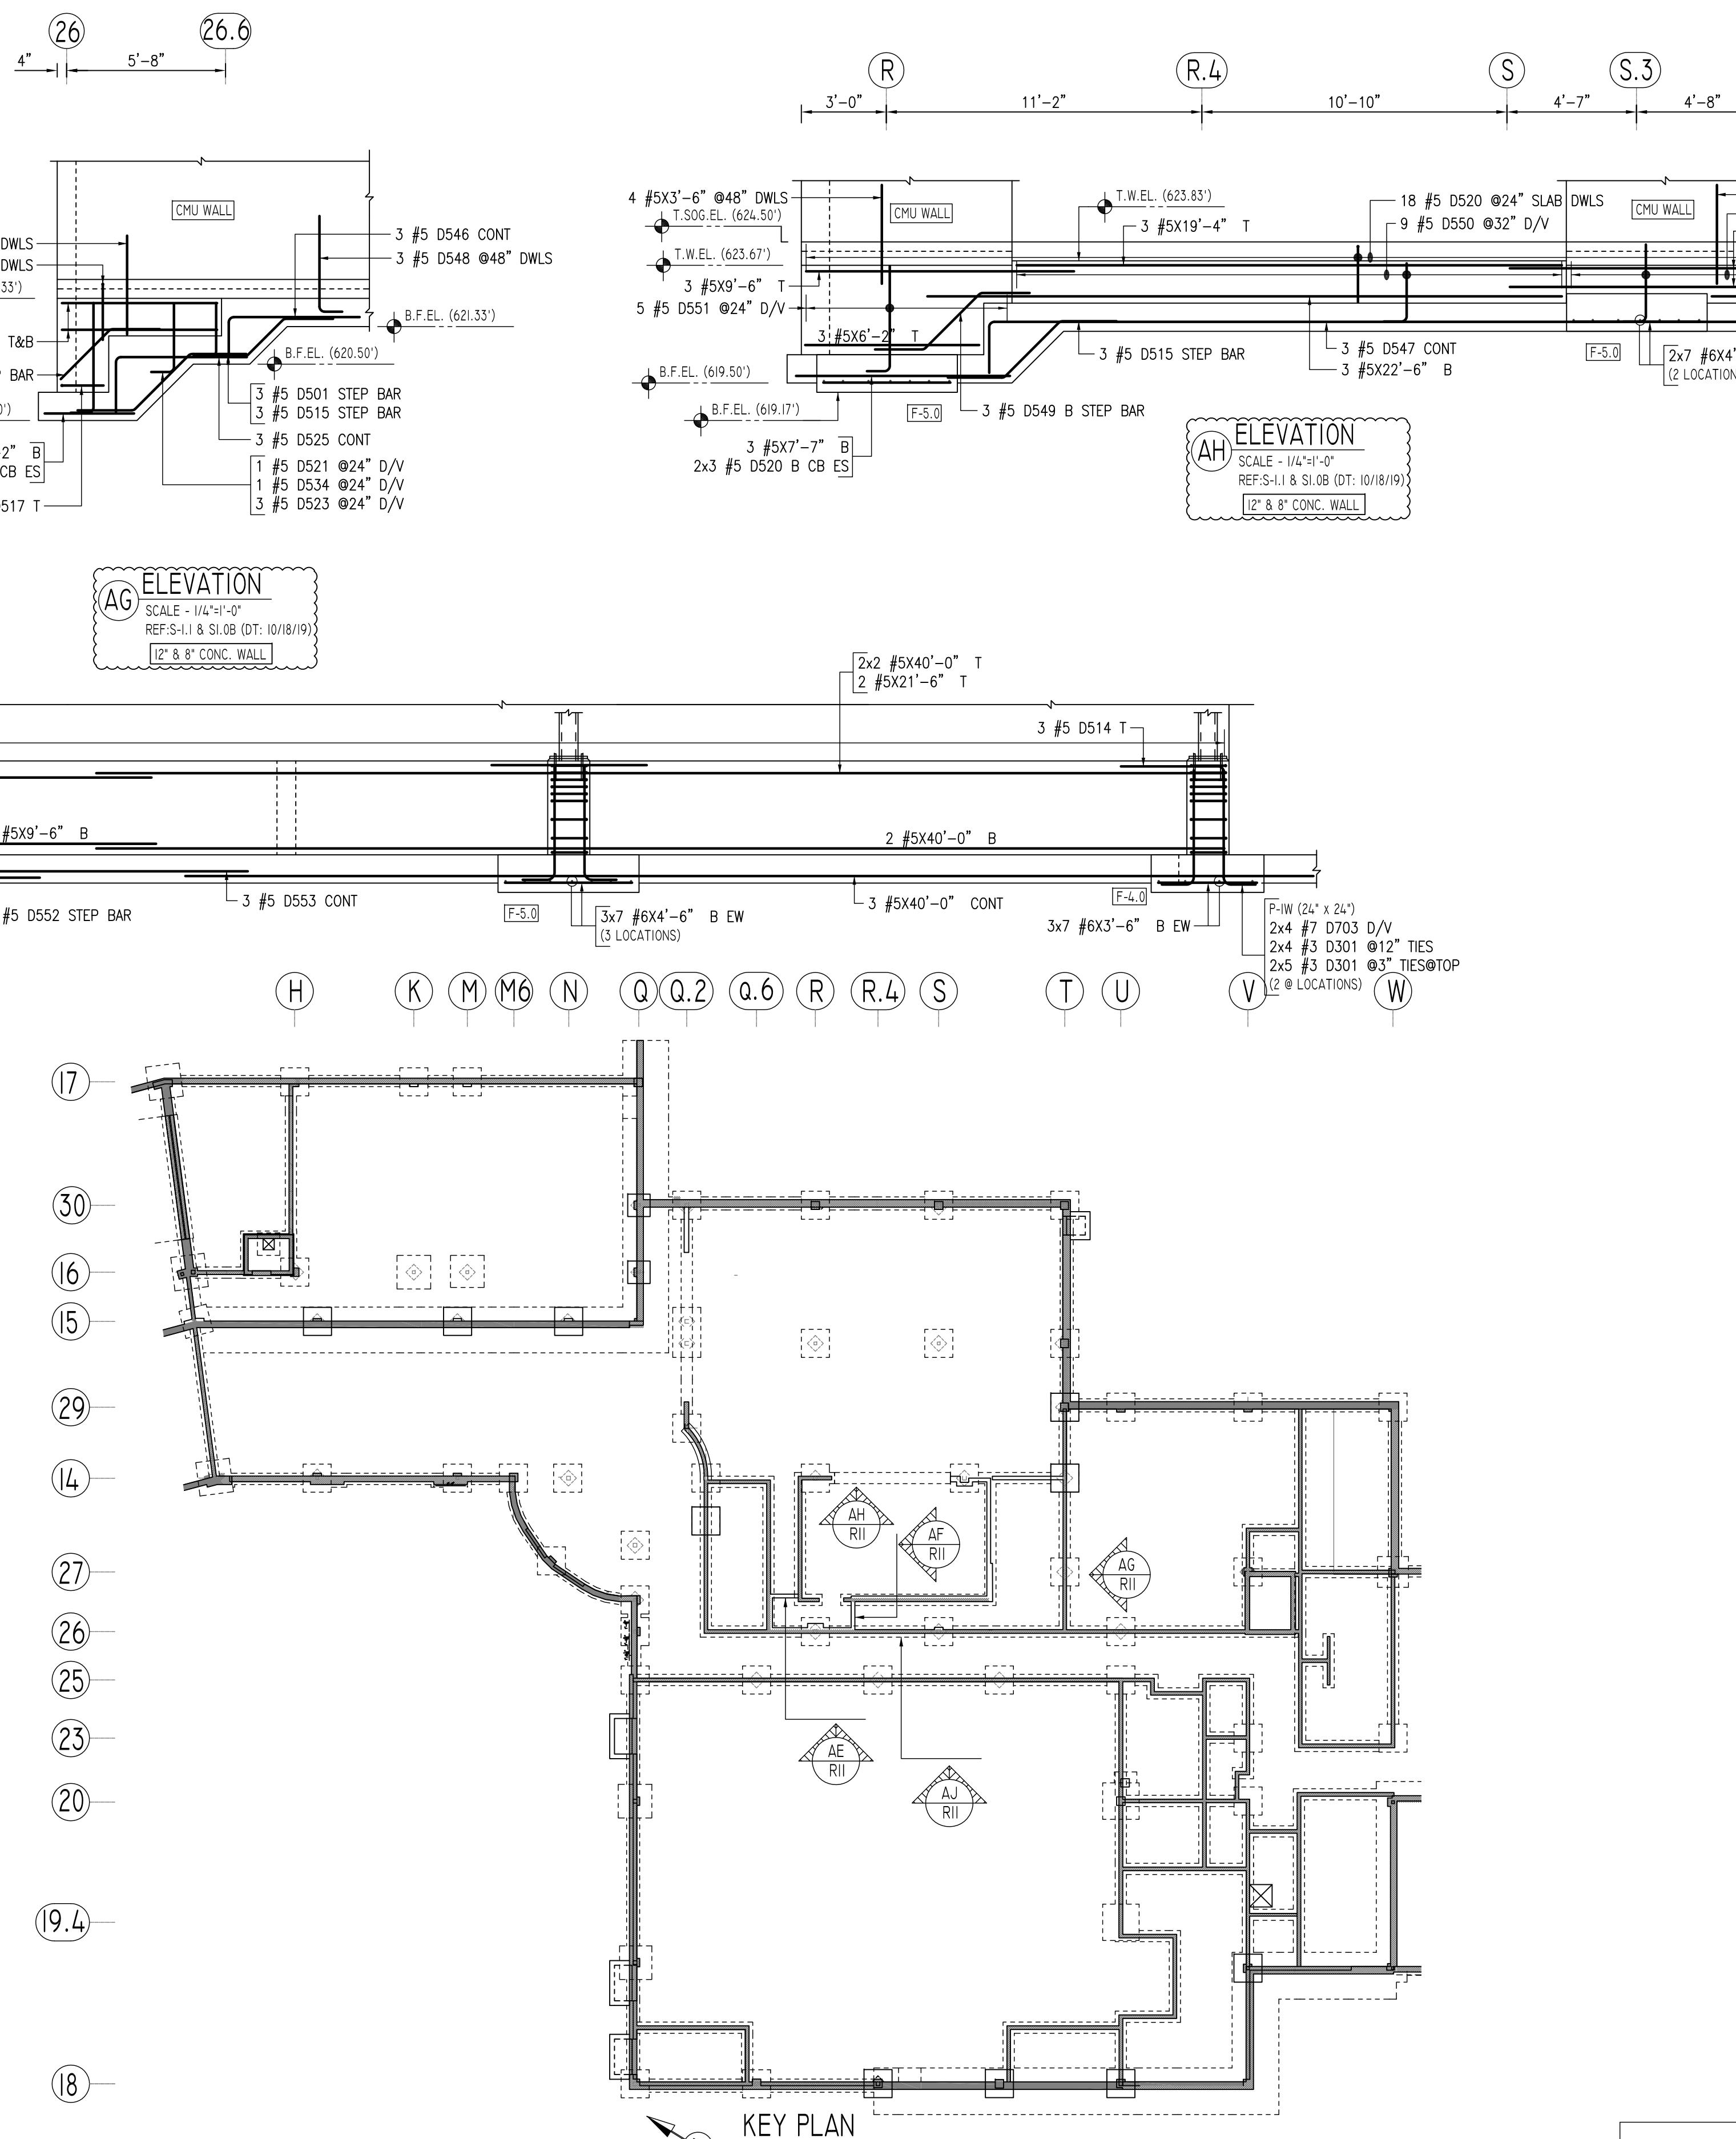


Abbreviations:	
I.F.=Inside Face	OPNG=Opening
O.F.=Outside Face	BAL=Balance
E.F.=Each Face	BTW=Between
D.WL=Dowel	CI=Construction Joint
V=Vertical	CLR=Clearance
H=Horizontal	CMU=Concrete Masonry Unit
C.R.=Corner Bar	CONT=Continuous
S.DWL=Slab Dowel	EA=Each
E.W.=Each Way	Elev.=Elevation
B.BOT=Bottom	EMB=Embedment
T=Top	SW=Short Way
MDWL=Masonry Dowel	LW=Long Way
B.B.=Bond Beam	(BL)=Black Bar
ALT=Alternate	(EP)=Epoxy Bar
Approx.=Approximate	(GA)=Galvanized


NOTICE
Shortages, improper fabrication or claims for any other reason must be reported to this company within a period of 15 days of delivery. This company reserves the right to inspect prior to replacement or reconditioning of nonconforming material, and will not honor charges for work done in the field without specific authorization from this company.

REINFORCING STEEL PLACING DRAWINGS ONLY USE IN CONJUNCTION WITH CONTRACT DRAWINGS & SPECIFICATIONS. ELEVATIONS & DIMENSIONS SHOWN ON THIS DRAWING ARE FOR DETAILING PURPOSES ONLY AND SHOULD NOT BE USED FOR CONSTRUCTION UNLESS VERIFIED BY ENGINEER OR CONTRACTOR.

PROJECT	WENDELL CROSS ELEMENTARY SCHOOL		
LOCATION	WATERBURY, CONNECTICUT		
ARCHITECT	—		
ENGINEER	SZEWCAZK ASSOCIATES		
CUSTOMER	G&G CONCRETE		
DRAWN BY:	KAS/MRS	DATE:	02/18/20
		REVIEWED BY:	T/L
		JOB NO.:	20009
DRAWING NO.:	ÁREA-A FOUNDATION WALL	DRAWING NO.:	R12
	ELEVATION U TO Z REINF. DETAIL		

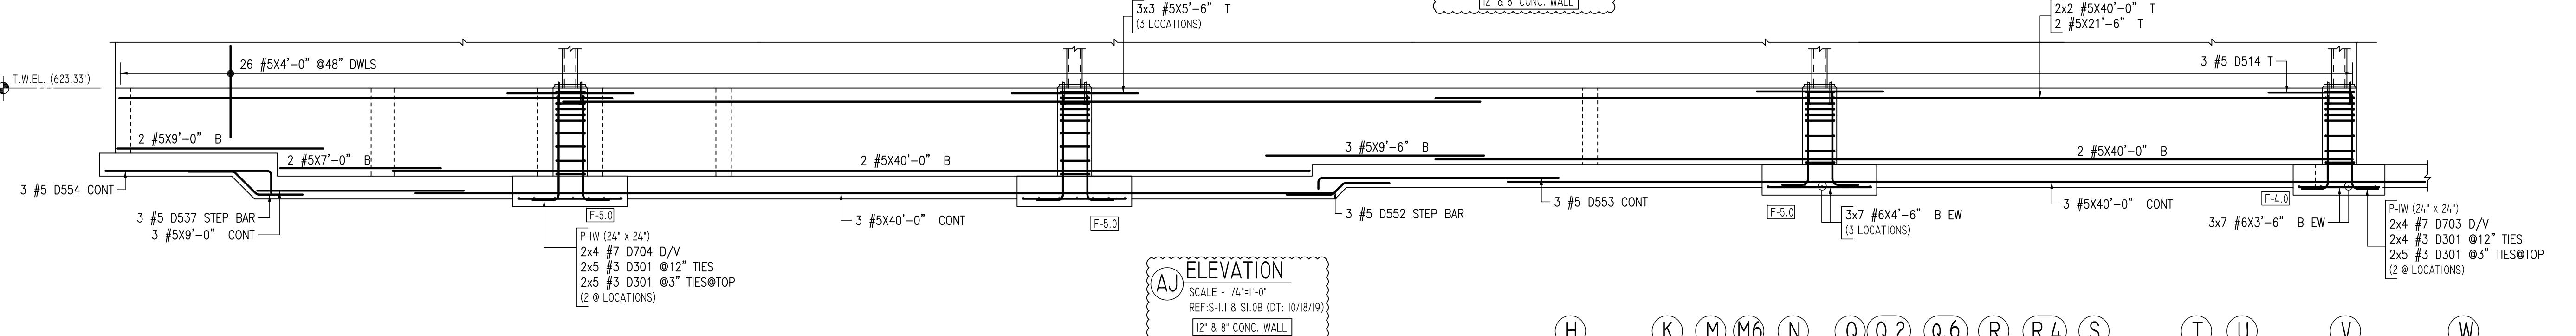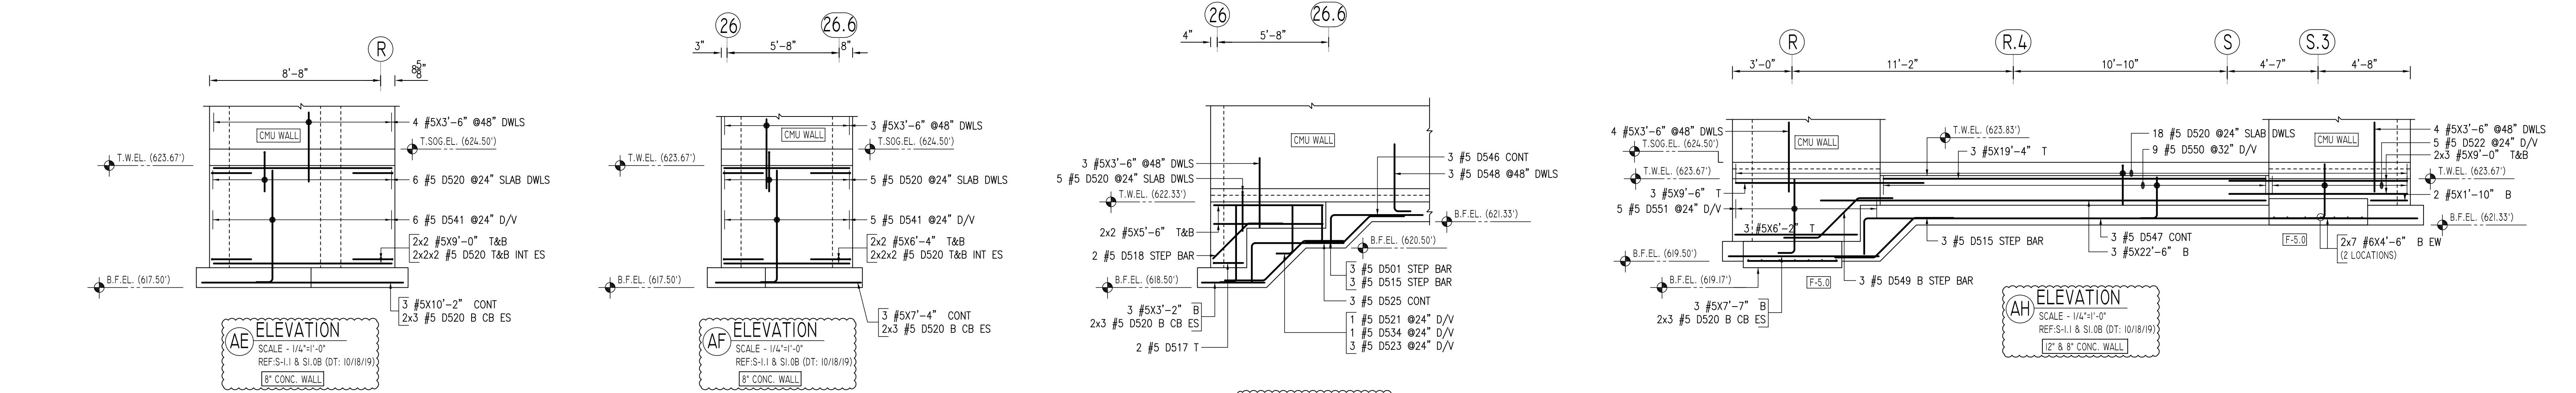

BENDING DETAILS.																
Bar Mark	Qty	Size	Total length	Type	'A'	'B'	'C'	'D'	'E'	'F'	'G'	'H'	'I'	'K'	'O'	'R'
D301	38	#3	5'8" 11"	4"	13"	13"	13"	13"	13"	4"	2 1/2"					
D501	3	#5	5'4 1/2" 3"		19"	110 1/2"	19"				14 1/2"		13 1/2"	49 1/2"		
D514	3	#5	4'6" 2"	10"		38"										
D515	6	#5	6'10" 3"		20"	2'10"	20"				20 1/2"		1'11 1/2"	5'11 1/2"		
D517	2	#5	3'6" 17"		16"	20"										
D518	2	#5	4'3" 3"		19"	26"					19 1/2"		19 1/2"	36 1/2"		
D520	74	#5	4'0" 17"		20"	20"										
D521	1	#5	2'9" 2"		10"	110"										
D522	5	#5	3'7" 2"		10"	29"										
D523	3	#5	4'9" 2"		10"	311"										
D525	3	#5	6'8" 10"		20"	4'8"										
D526	1	#5	3'3" 2"		10"	25"										
D527	3	#5	5'5 1/2" 3"		20"	15 1/2"	20"				10 1/2"		11 1/2"	4'11 1/2"		
D541	11	#5	6'6" 2"		10"	58"										
D546	3	#5	6'9" 10"		14"	4'8"										
D547	3	#5	2'8" 10"		110"	28 0"										
D548	3	#5	4'3" 2"		10"	35"										
D549	3	#5	6'4" 3"		19"	2'10"	19"				20 1/2"		1'11 1/2"	55 1/2"		
D550	9	#5	2'11" 2"		10"	21"										
D551	5	#5	4'7" 2"		10"	39"										
D552	3	#5	4'8 1/2" 3"		20"	8 1/2"	20"				6 1/2"		5 1/2"	45 1/2"		
D553	3	#5	10'0" 17"		6"	10'6"										
D554	3	#5	8'3" 17"		10"	7'3"										
D703	8	#7	5'3" 2"		12"	4"										
D704	8	#7	5'9" 2"		12"	47"										

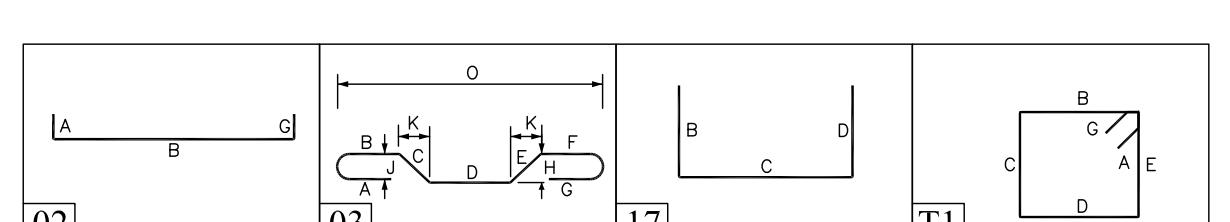



LAP SCHEDULE	
SIZE	36 X BD
#4	LAP
#5	18"
#6	23"
#7	27"
	32"

A/E PLEASE VERIFY
LAP VALUE (TYP.)

TYPICAL REINFORCING BAR CLEARANCE TABLE	
LOCATION	MIN. COVER
FOOTINGS AGAINST EARTH	3" CLR
COLUMNS AND PIERS (TIES, REINF.)	1 1/2" CLR
WALLS INTERIOR FACE	1 1/2" CLR
WALLS EXTERIOR FACE (#5 & SMALLER)	1 1/2" CLR
WALLS INTERIOR FACE (#6 & LARGER)	2" CLR
WALLS EXTERIOR FACE (#6 & LARGER)	2" CLR

A/E PLEASE VERIFY
COVER VALUE (TYP.)

ALL BARS IN THIS DRAWING
ASTM A615 GRADE 60
BLACK UNCOATED

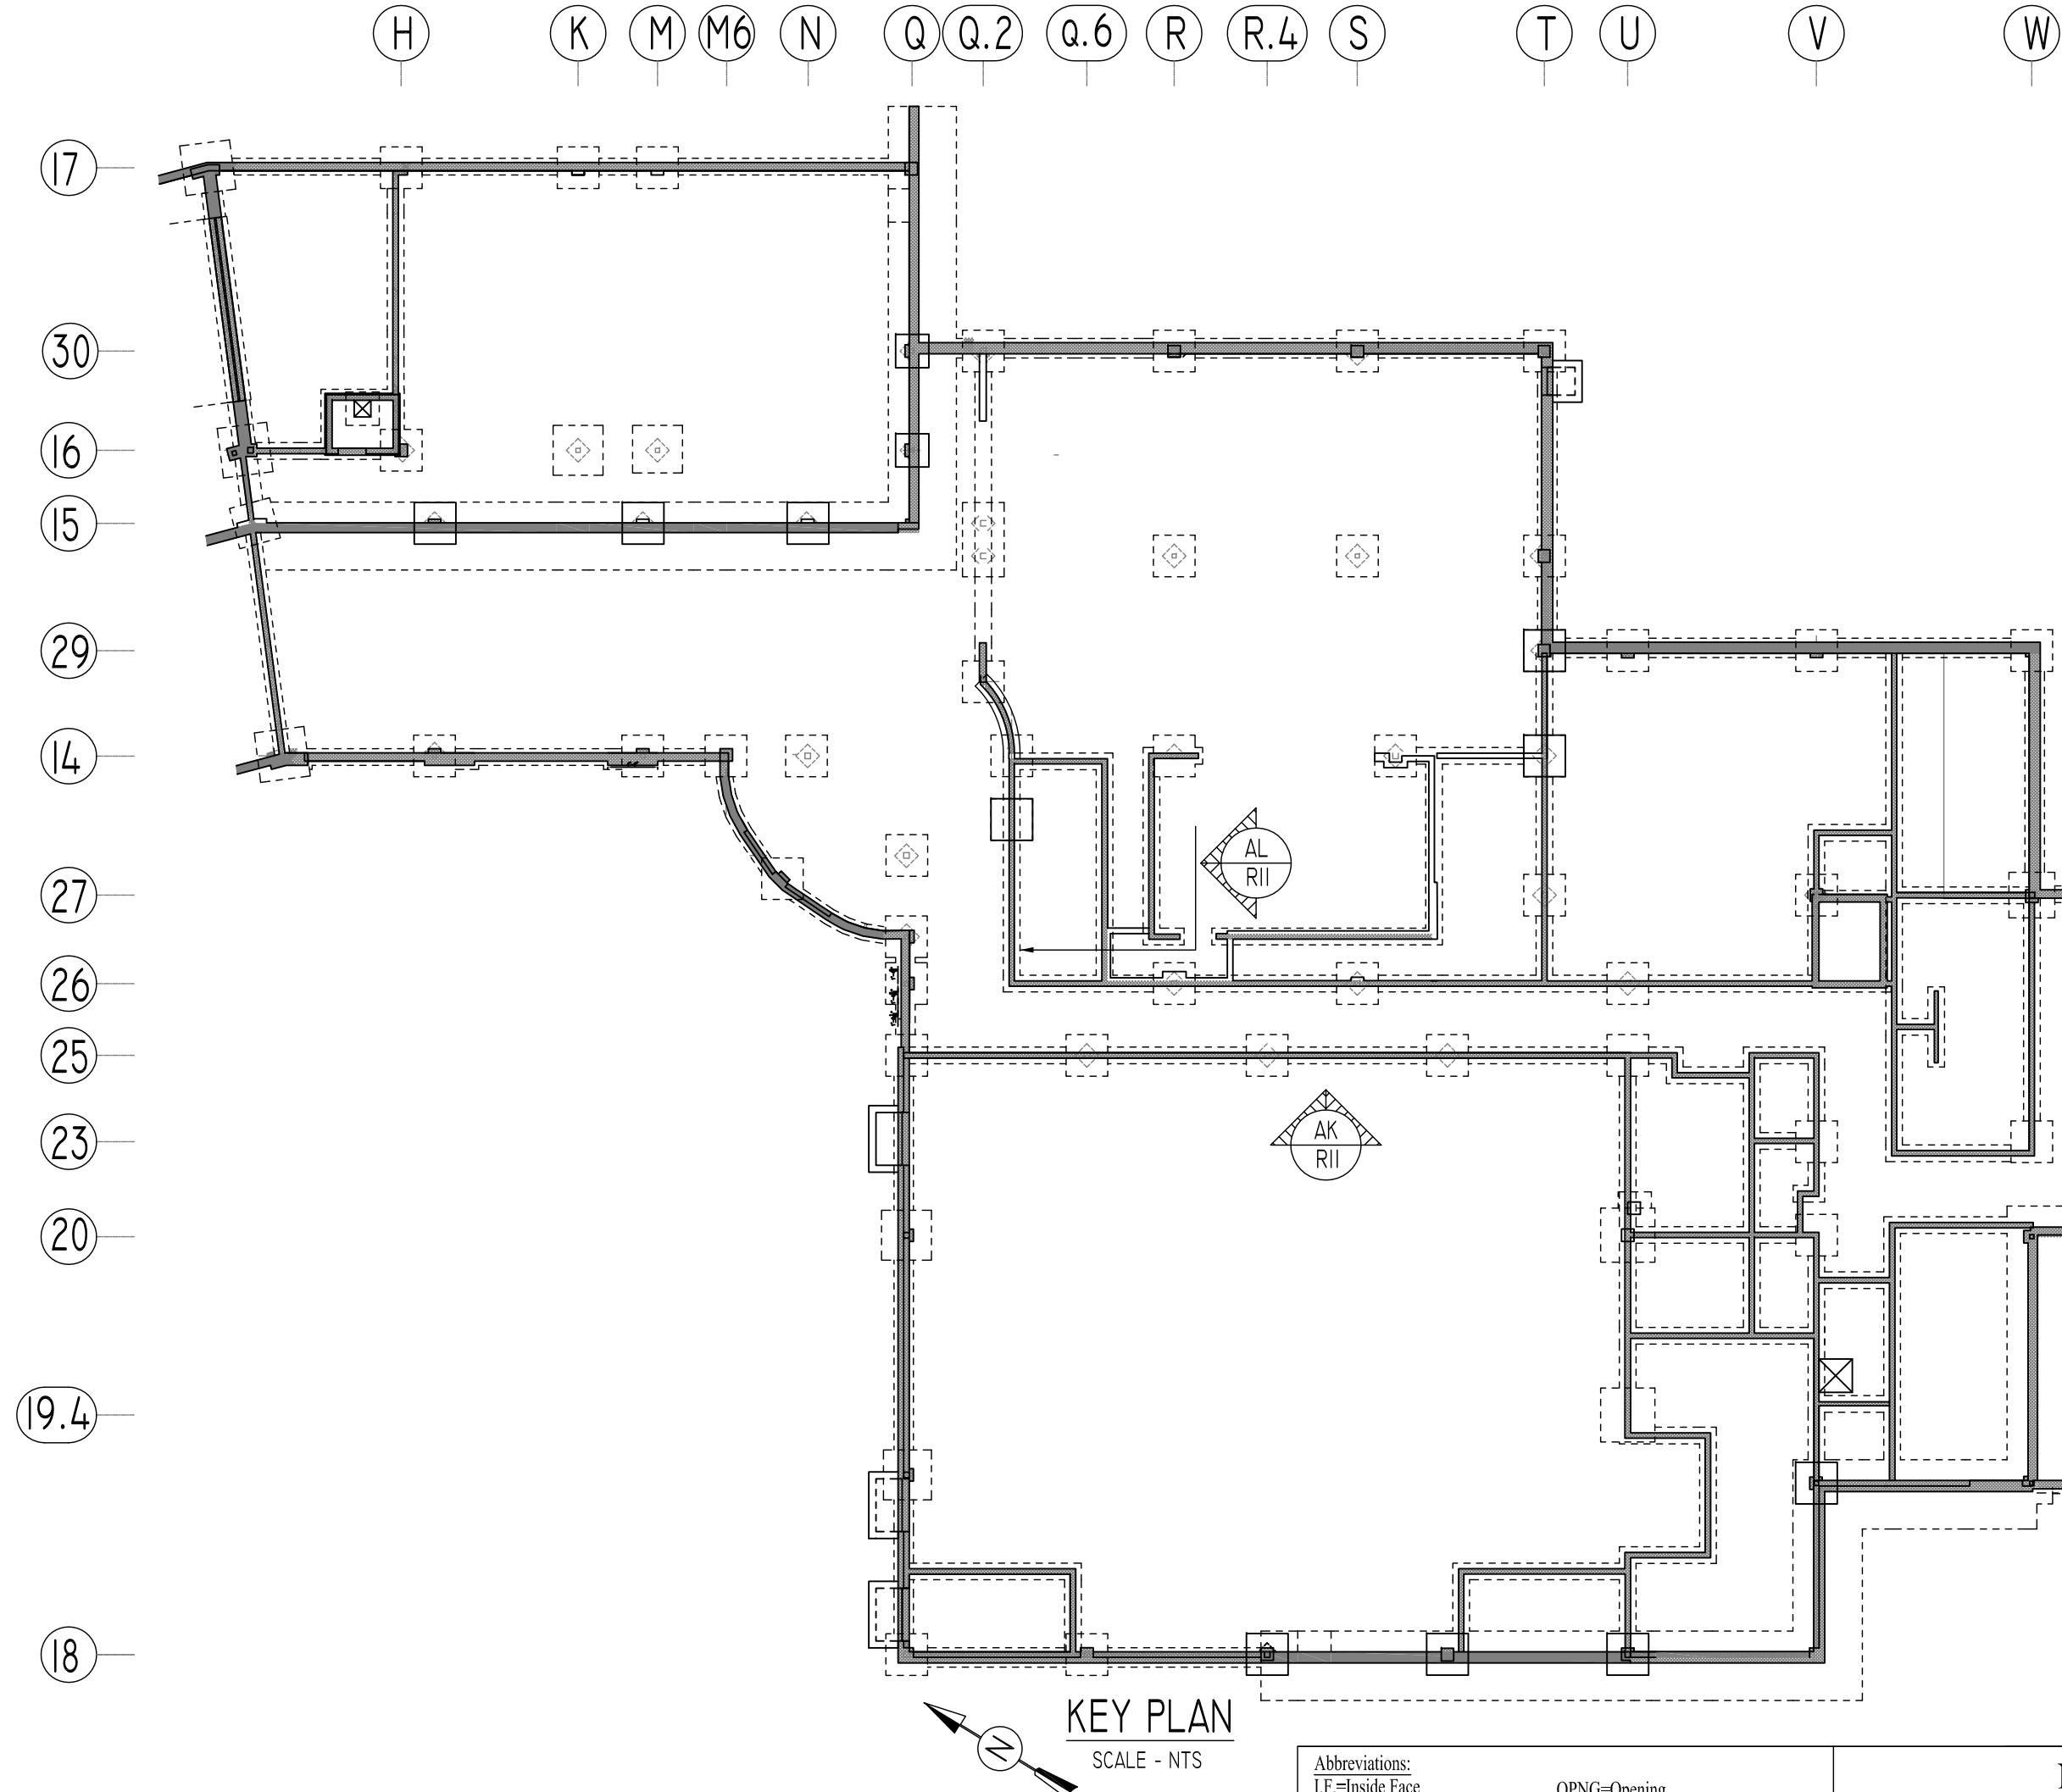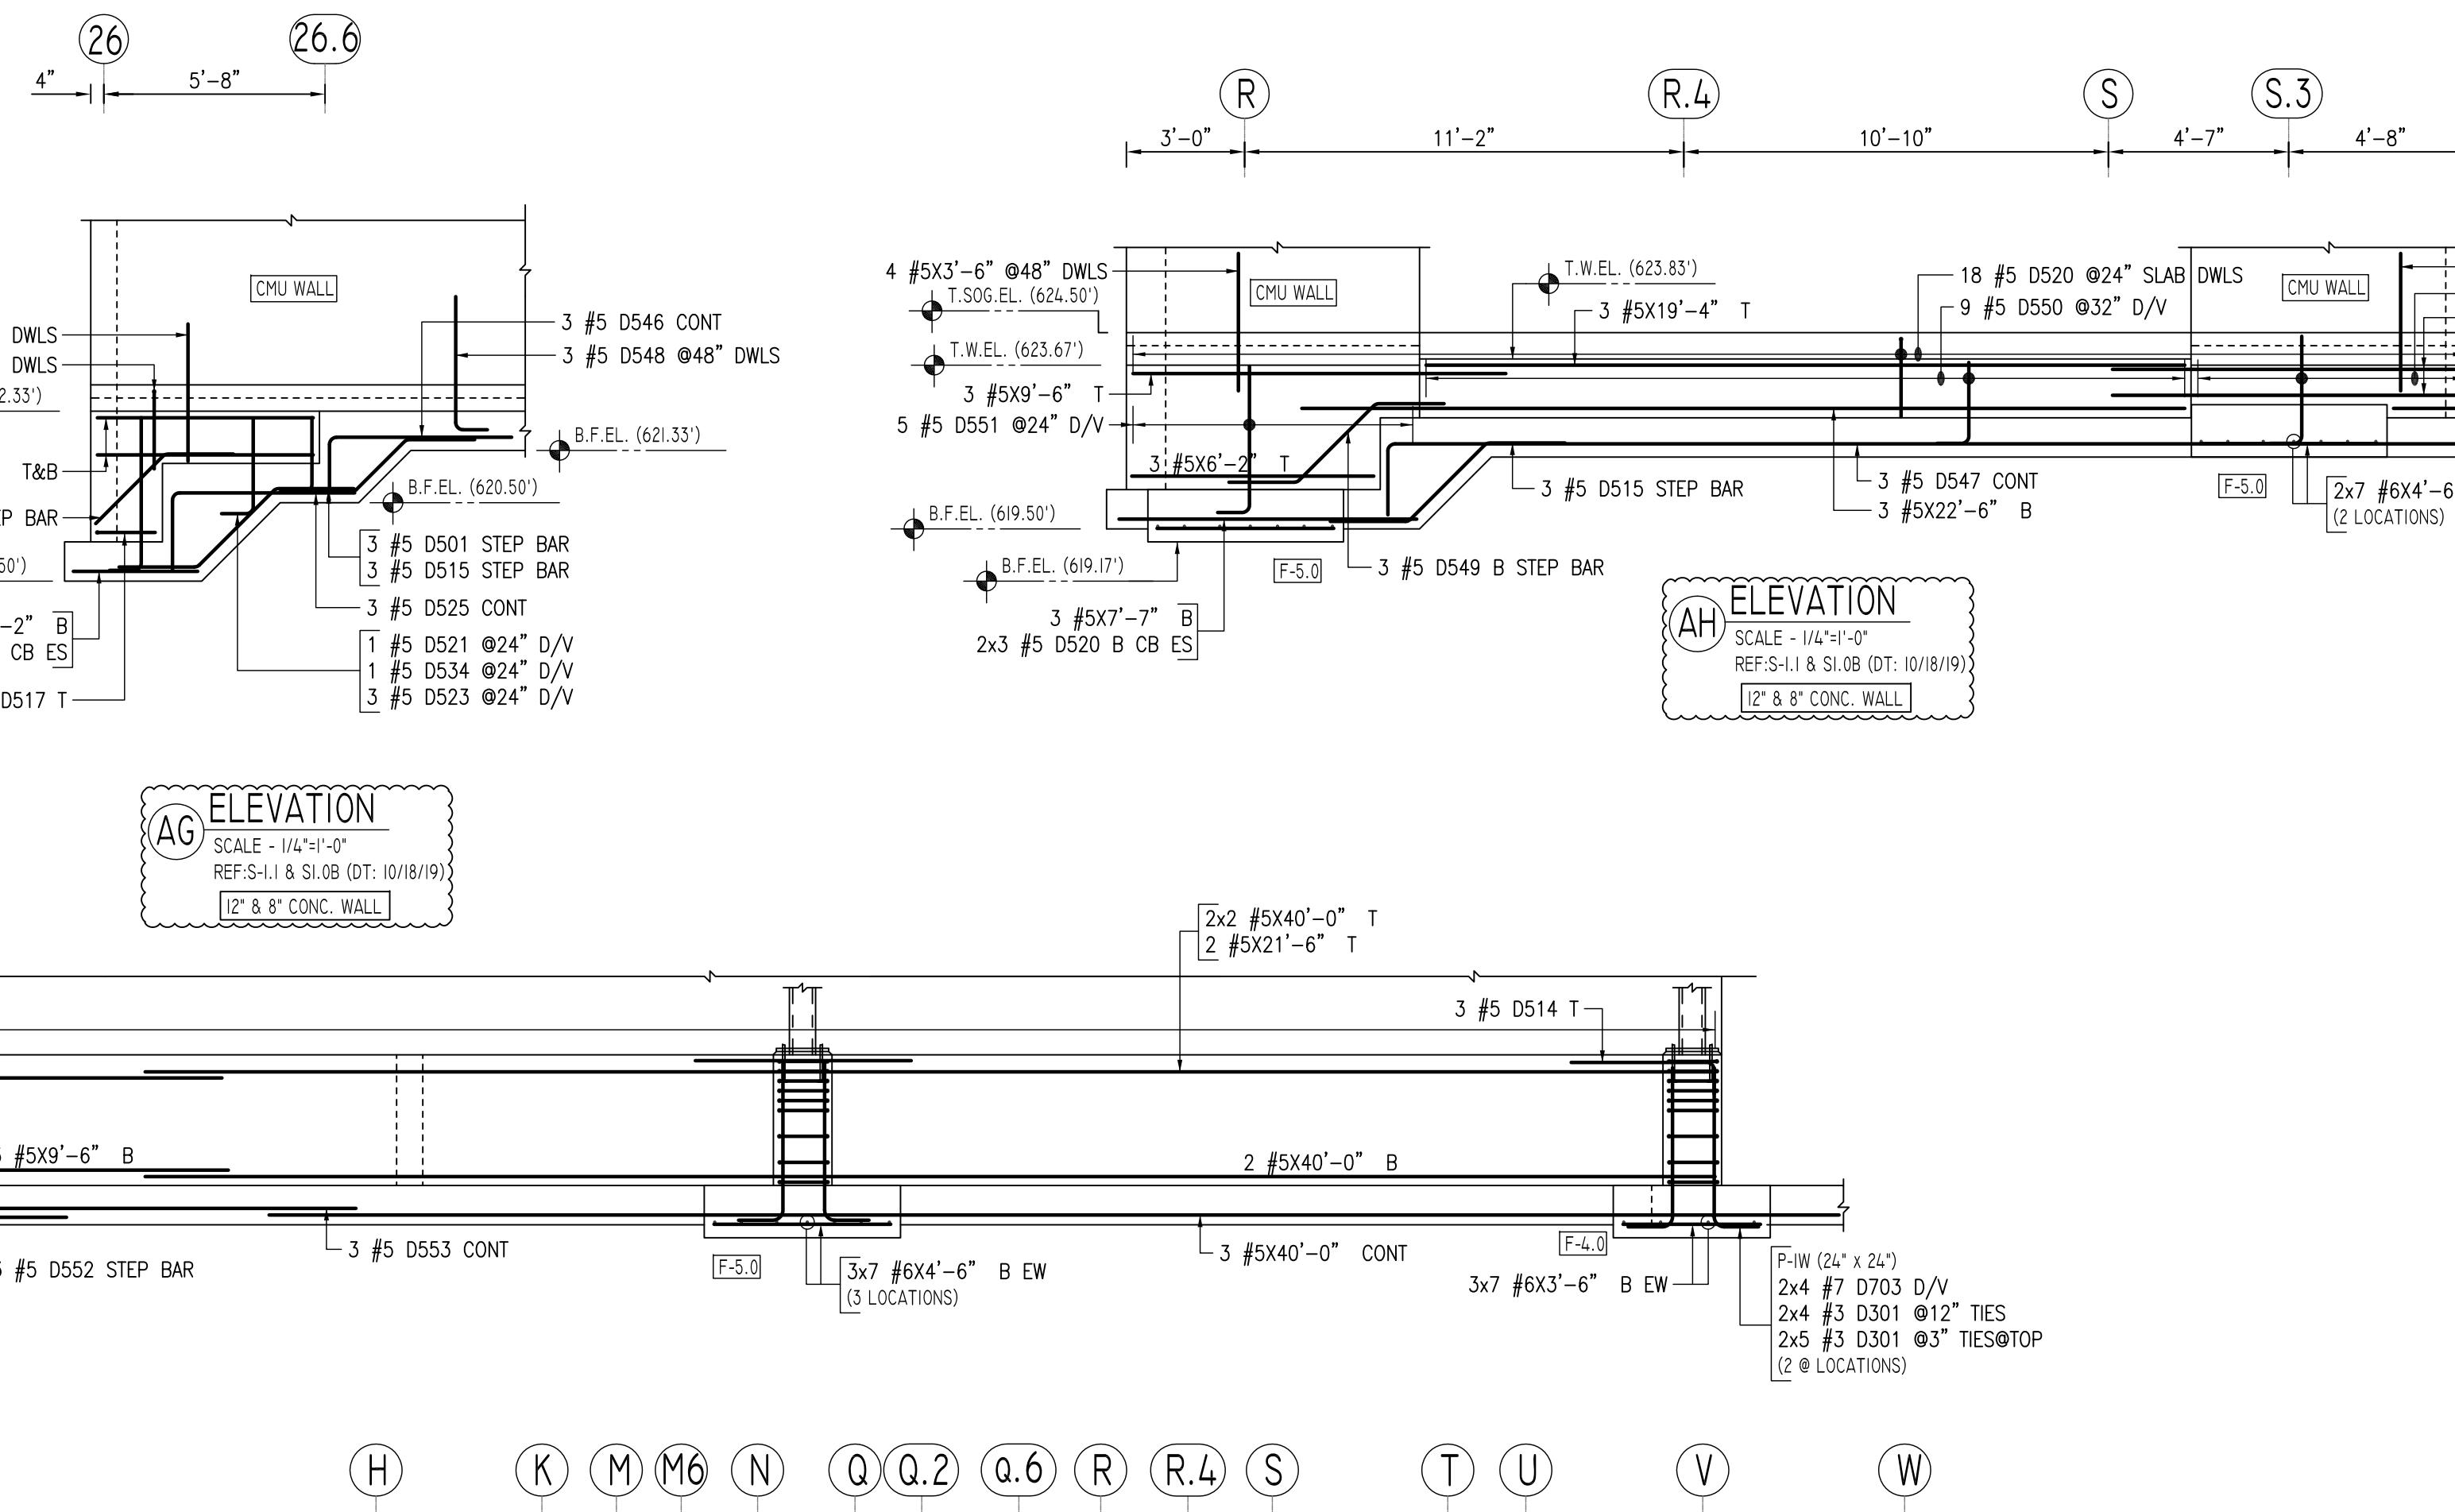

REVISION MARK	REVISION DETAILS	DATE
0	FOR APPROVAL	02/18/2020
PROJECT: WENDELL CROSS ELEMENTARY SCHOOL		
LOCATION: WATERBURY, CONNECTICUT		
ARCHITECT:	—	
ENGINEER:	SZEWCAZK ASSOCIATES	
CUSTOMER:	G&G CONCRETE	
DRAWN BY:	DATE: 02/18/20	REVIEWED BY: T/L
JOB NO.: 20009		
DRAWING BY:	ÁREA-A FOUNDATION WALL	
ELEVATION U TO Z REINF. DETAIL		
R13		