
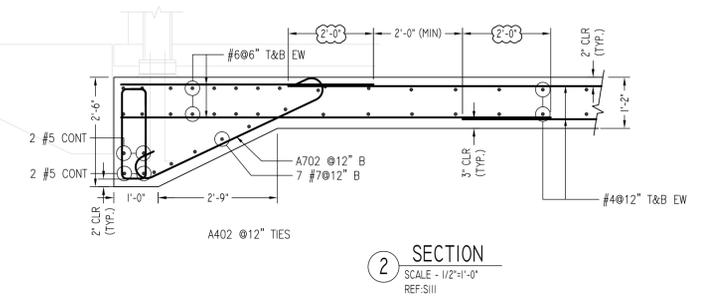


FOUNDATION MAT SLAB REINFORCEMENT DETAILS  
 SCALE - 1/16"=1'-0"  
 REF: SIII

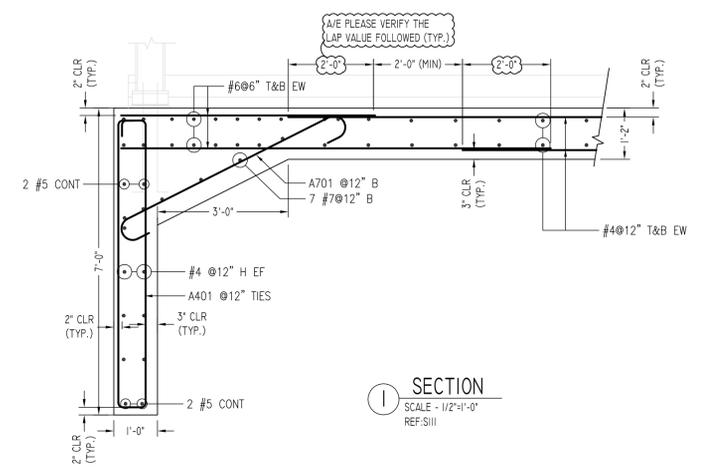

LAP SCHEDULE

SIZE	4000 PSI	
	TOP	OTHERS
#3	24"	19"
#4	32"	25"
#5	40"	31"
#6	48"	37"
#7	70"	54"
#8	80"	62"
#9	91"	70"
#10	102"	79"
#11	113"	87"

TYPICAL REINFORCING BAR CLEARANCE TABLE

LOCATION	MIN. COVER
FOOTINGS AGAINST EARTH	3" CLR
WALLS INTERIOR FACE	3" CLR
WALLS EXTERIOR FACE	2" CLR
SLAB TOP	2" CLR
SLAB BOTTOM	3" CLR

ALL BARS IN THIS DRAWING  
 ASTM A615 GRADE 60  
 BLACK UNCOATED

REVISION MARK	REVISION DETAILS	DATE
0	FOR APPROVAL	02/25/2020

- Abbreviations:  
 I.F.=Inside Face  
 O.F.=Outside Face  
 E.F.=Each Face  
 DWL=Dowel  
 V=Vertical  
 H=Horizontal  
 C.B.=Corner Bar  
 S.DWL=Slab Dowel  
 E.W.=Each Way  
 B.BOT=Bottom  
 T=Top  
 MDWL=Masonry Dowel  
 B.B=Bond Beam  
 ALT.=Alternate  
 Approx.=Approximate
- OPNG=Opening  
 BAL.=Balance  
 BTW=Between  
 CJ=Construction Joint  
 CLR=CLEARANCE  
 CMU=Concrete Masonry Unit  
 CONT.=Continuous  
 EA.=Each  
 Elev.=Elevation  
 EMB=Embedment  
 SW=Short Way  
 LW=Long Way  
 (BL)=Black Bar  
 (EP)=Epoxy Bar  
 (GA)=Galvanized

**NOTICE**


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PROJECT	B&M MEATS		
LOCATION	WILMINGTON, DELAWARE		
ARCHITECT	-		
ENGINEER	DUMACK ENGINEERING		
CUSTOMER	JAR EXCAVATING		
DRAWN BY:	DATE:	REVIEWED BY:	JOB NO.
PTJ/MRS	02/25/20	T/L	20017
DRAWING TITLE:			DRAWING NO.:
FOUNDATION MAT SLAB REINFORCEMENT DETAILS			R01


4.7 5.4 7.1 7.5 8 9 10  
 8'-3" 24'-11" 21'-4 1/2" 21'-4 1/2" 21'-4 1/2" 21'-4 1/2"

B.6  
 28'-8"  
 C.5  
 20'-9"  
 E.6  
 20'-9"  
 G.1  
 23'-4"  
 H.1



Release Code: R1

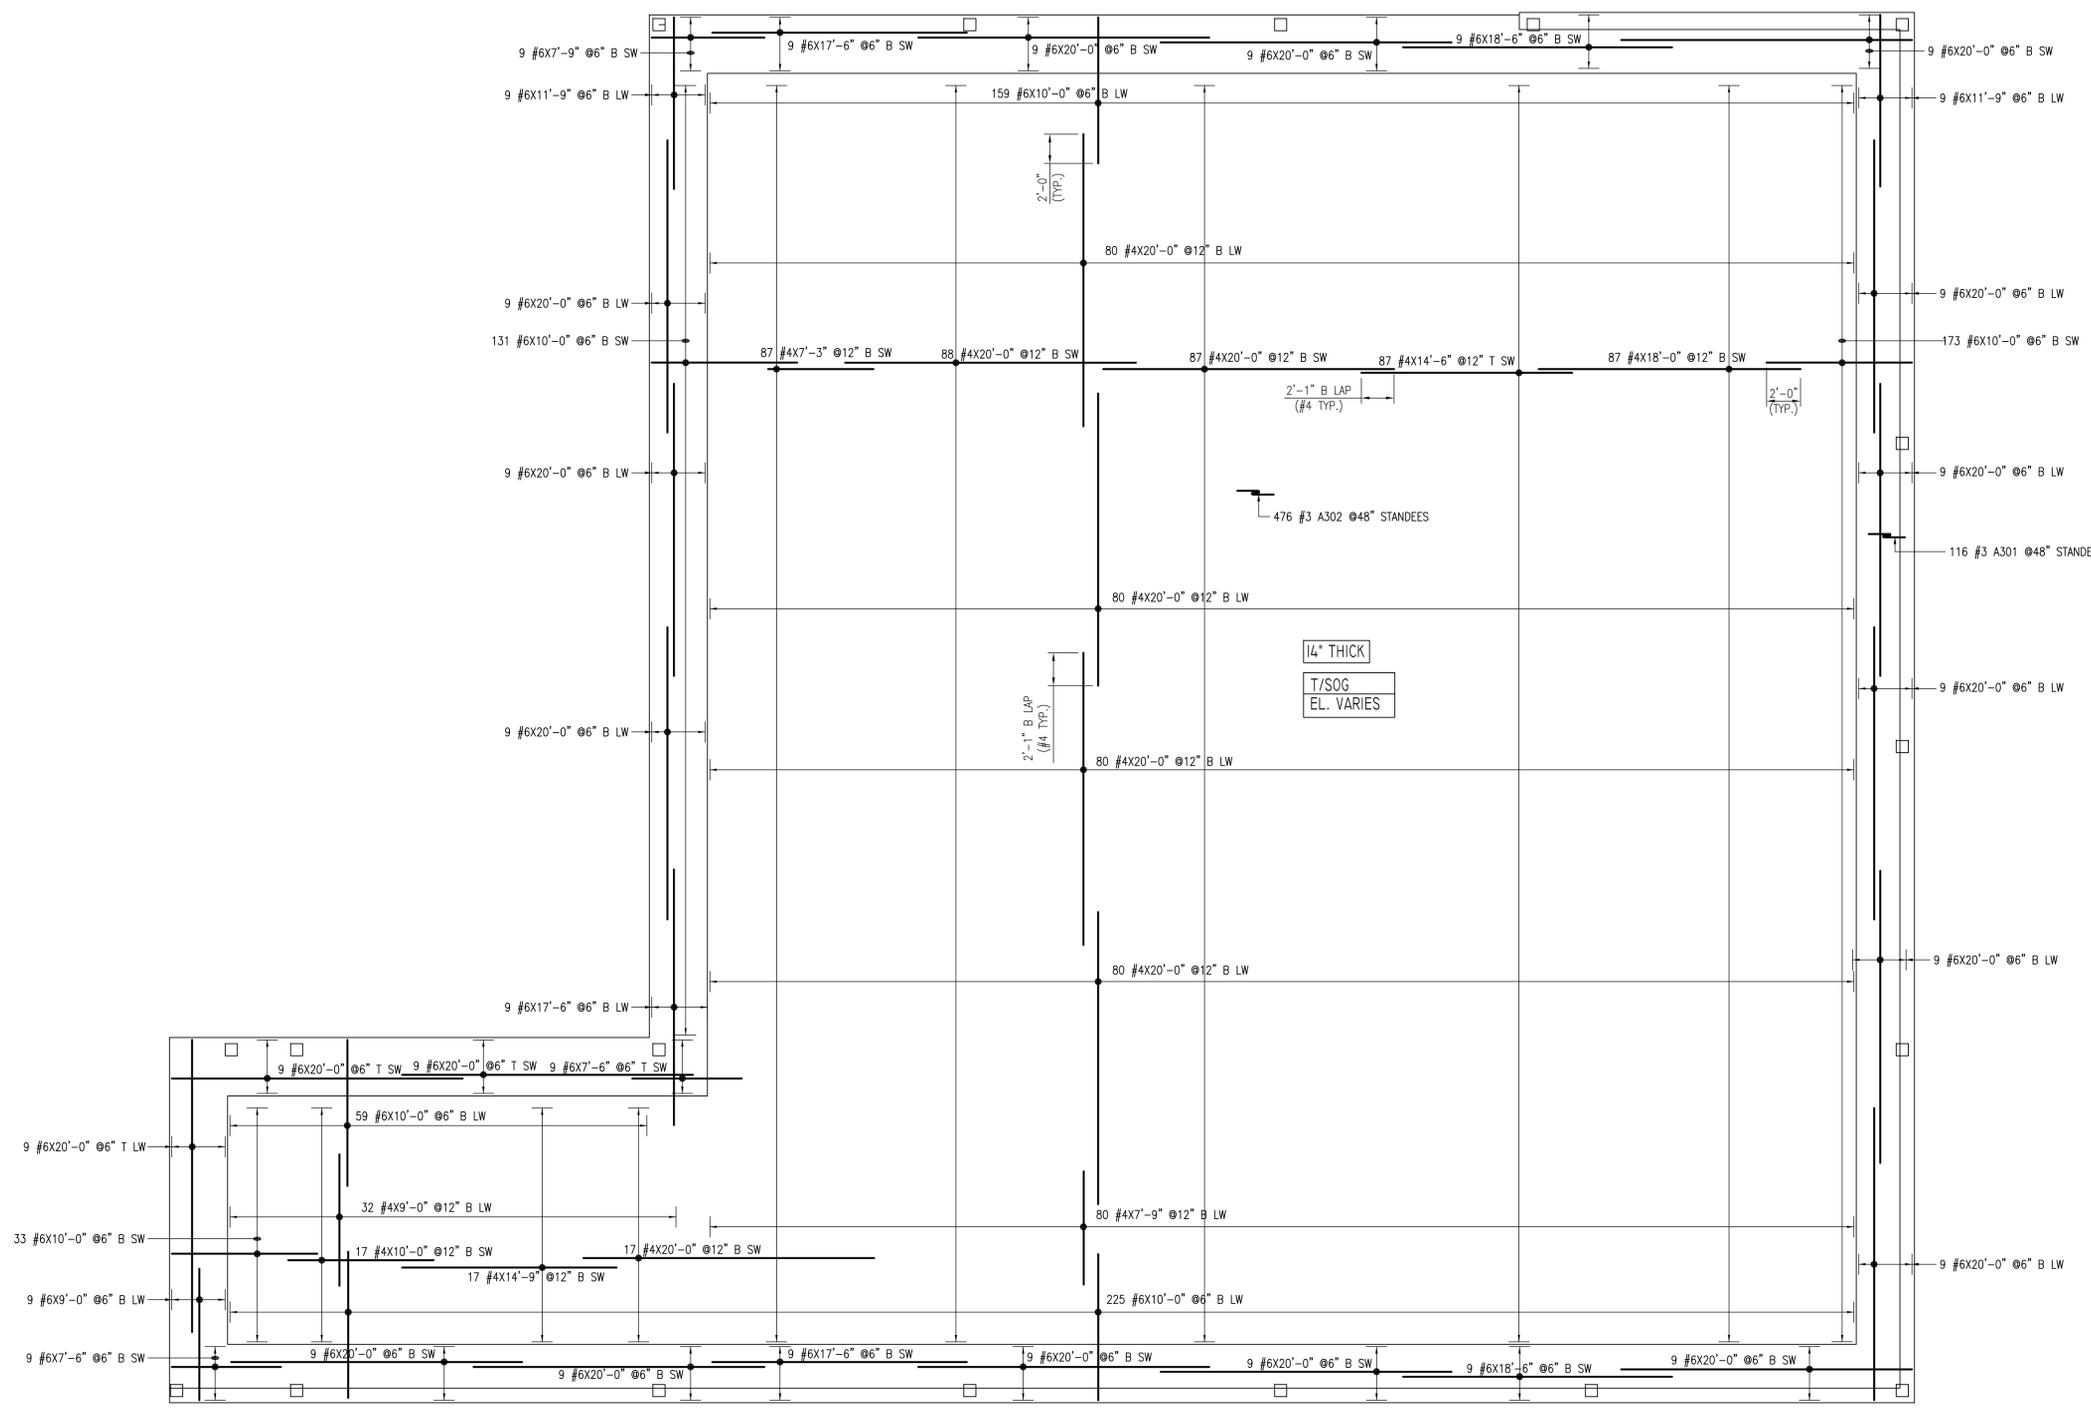Bar Mark	Qty	Size	Total length	BENDING DETAILS											
				'A'	'B'	'C'	'D'	'E'	'F'	'G'	'H'	'I'	'J'	'K'	'L'
A301	116	#3	4'4 1/2"		18'	6'	6'	6'	18'		6'	6'	6'	3'	
A302	476	#3	4'8 1/2"		18'	7'	6'	7'	18'		7'	7'	3 1/2'		

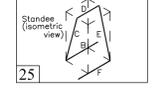

LAP SCHEDULE

SIZE	4000 PSI	
	TOP	OTHERS
#3	24"	19"
#4	32"	25"
#5	40"	31"
#6	48"	37"
#7	70"	54"
#8	80"	62"
#9	91"	70"
#10	102"	79"
#11	113"	87"

TYPICAL REINFORCING BAR CLEARANCE TABLE

LOCATION	MIN. COVER
FOOTINGS AGAINST EARTH	3" CLR
WALLS INTERIOR FACE	3" CLR
WALLS EXTERIOR FACE	2" CLR
SLAB TOP	2" CLR
SLAB BOTTOM	3" CLR

ALL BARS IN THIS DRAWING  
 ASTM A615 GRADE 60  
 BLACK UNCOATED

BOTTOM B1 & B2 LAYER MAT SLAB REINFORCEMENT DETAILS  
 SCALE - 1/16"=1'-0"  
 REF:SHH

REVISION MARK	REVISION DETAILS	DATE
0	FOR APPROVAL	02/25/2020

- Abbreviations:  
 IF=Inside Face  
 OF=Outside Face  
 EF=Each Face  
 DWL=Dowel  
 V=Vertical  
 H=Horizontal  
 C-B=Corner Bar  
 S-DWL=Slab Dowel  
 E-W=Each Way  
 B-BOT=Bottom  
 T=Top  
 MDWL=Masonry Dowel  
 B-B=Bond Beam  
 ALT=Alternate  
 Approx=Approximate
- OPNG=Opening  
 BAL=Balance  
 BTW=Between  
 C=Construction Joint  
 CLR=CLEARANCE  
 CMU=Concrete Masonry Unit  
 CONT=Continuous  
 EA=Each  
 Elev=Elevation  
 EMB=Embedment  
 SW=Short Way  
 LW=Long Way  
 (BL)=Black Bar  
 (EP)=Epoxy Bar  
 (GA)=Galvanized


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PROJECT	B&M MEATS							
LOCATION	WILMINGTON, DELAWARE							
ARCHITECT	-							
ENGINEER	DUMACK ENGINEERING							
CUSTOMER	JAR EXCAVATING							
DRAWN BY:	PTJ/MRS	DATE:	02/25/20	REVIEWED BY:	T/L	JOB NO.:	20017	
DRAWING TITLE:	BOTTOM B1 & B2 LAYER MAT REINFORCEMENT DETAILS						DRAWING NO.:	R1

4.7 8'-3" 5.4 24'-11" 7.1 21'-4 1/2" 7.5 21'-4 1/2" 8 21'-4 1/2" 9 21'-4 1/2" 10

B.6 28'-8"  
C.5 20'-9"  
E.6 20'-9"  
G.1 23'-4"  
H.1



**LAP SCHEDULE**  
4000 PSI

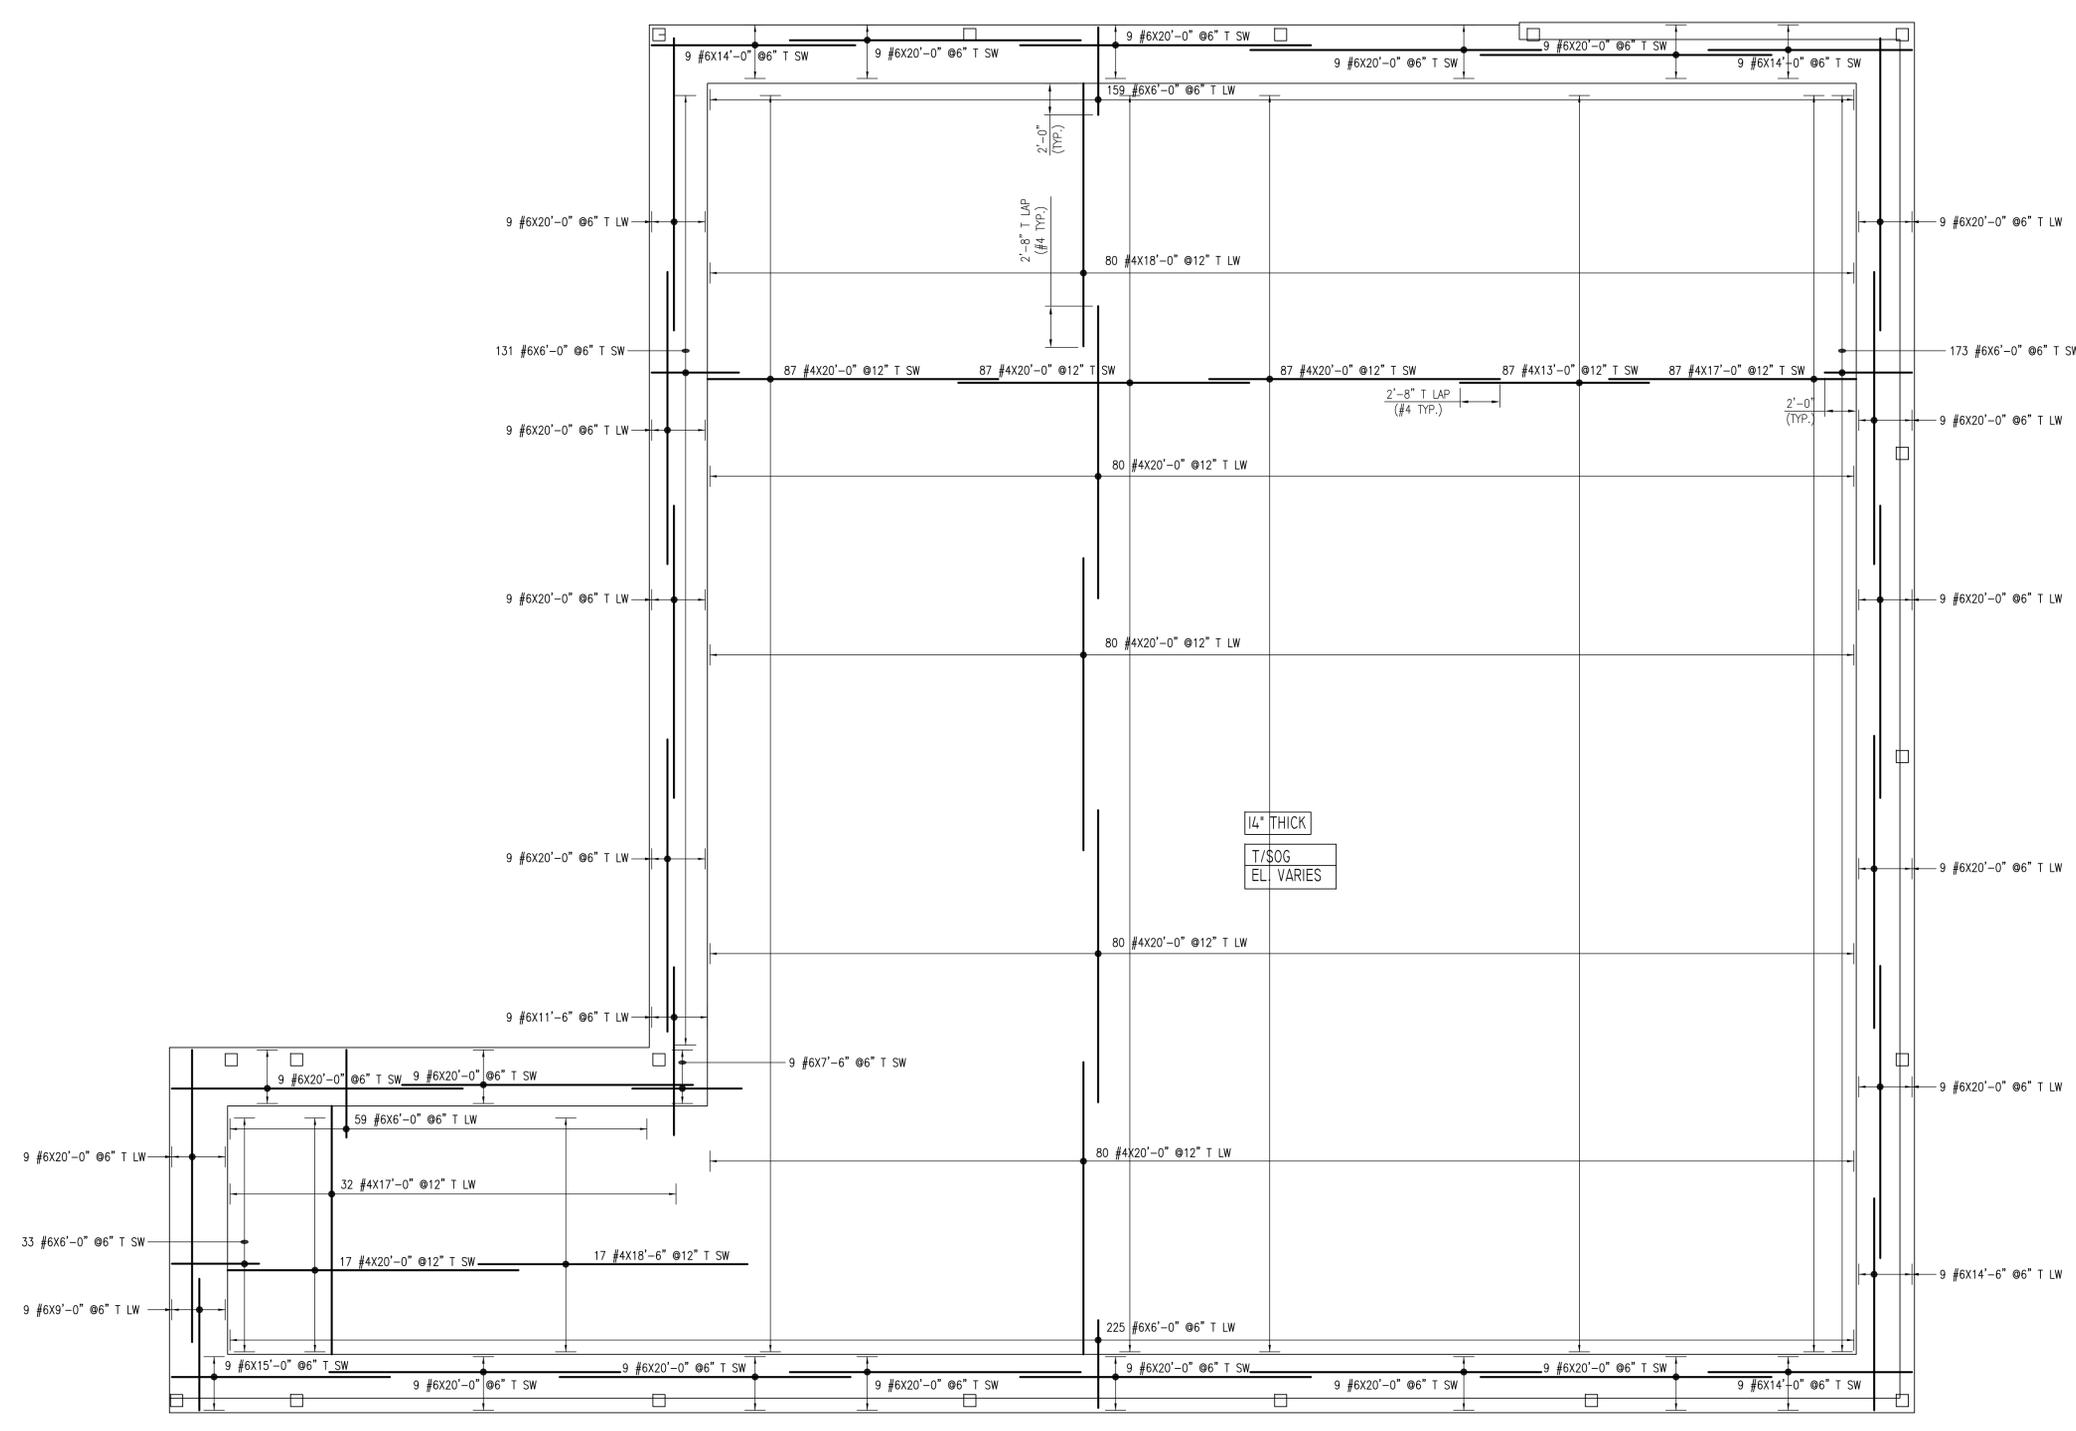SIZE	TOP	OTHERS
#3	24"	19"
#4	32"	25"
#5	40"	31"
#6	48"	37"
#7	70"	54"
#8	80"	62"
#9	91"	70"
#10	102"	79"
#11	113"	87"

PLEASE VERIFY THE LAP SCHEDULE FOLLOWED

**TYPICAL REINFORCING BAR CLEARANCE TABLE**

LOCATION	MIN. COVER
FOOTINGS AGAINST EARTH	3" CLR
WALLS INTERIOR FACE	3" CLR
WALLS EXTERIOR FACE	2" CLR
SLAB TOP	2" CLR
SLAB BOTTOM	3" CLR

PLEASE VERIFY THE CLEARANCE FOLLOWED

**ALL BARS IN THIS DRAWING  
ASTM A615 GRADE 60  
BLACK UNCOATED**

**TOP T1 & T2 LAYER MAT SLAB REINFORCEMENT DETAILS**  
SCALE - 1/8"=1'-0"  
REF:SH

REVISION MARK	REVISION DETAILS	DATE
0	FOR APPROVAL	02/25/2020

**ACCESSORIES SCHEDULE**


S. NO	ELEMENT	DESCRIPTION	HEIGHT	QUANTITY	LFT	REMARK
1	12" THK WIDTH BEAM	BEAM BOLTERS - BB @ 4'-0" C/C BEAM BOLTERS - 5'-0" LENGTH (PLASTIC TIPPED)	2"	-	330	FOR BEAM
2	5" THK SLAB ON GRADE	SLAB BOLTERS - SB @ 4'-0" C/C (PLASTIC TIPPED)	3"	-	1997	FOR SLAB

PLEASE VERIFY THE ACCESSORIES TYPE FOLLOWED


**Abbreviations:**  
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 OF=Outside Face  
 EF=Each Face  
 DWL=Dowel  
 V=Vertical  
 H=Horizontal  
 C-B=Corner Bar  
 S-DWL=Slab Dowel  
 E-W=Each Way  
 B-BOT=Bottom  
 T=Top  
 MDWL=Masonry Dowel  
 B-B=Bond Beam  
 ALT.=Alternate  
 Approx.=Approximate  
 OPNG=Opening  
 BAL=Balance  
 BTW=Between  
 C-Construction Joint  
 CLR=CLEARANCE  
 CMU=Concrete Masonry Unit  
 CONT=Continuous  
 EA=Each  
 Elev.=Elevation  
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 SW=Short Way  
 LW=Long Way  
 (BL)=Black Bar  
 (EP)=Epoxy Bar  
 (GA)=Galvanized

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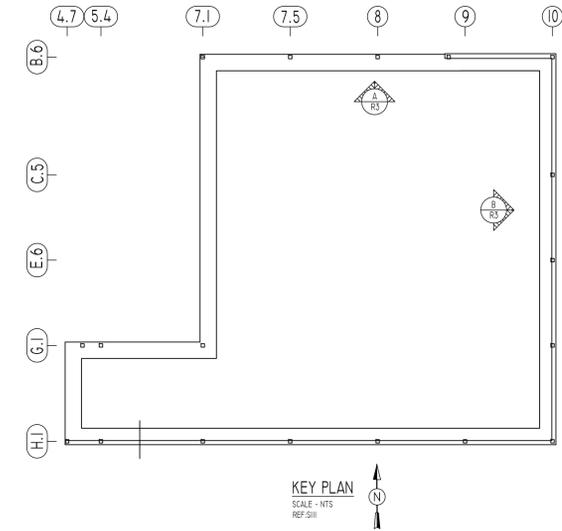
PROJECT	B&M MEATS		
LOCATION	WILMINGTON, DELAWARE		
ARCHITECT	-		
ENGINEER	DUMACK ENGINEERING		
CUSTOMER	JAR EXCAVATING		
DRAWN BY:	DATE:	REVIEWED BY:	JOB NO.
PTJ/MRS	02/25/20	T/L	20017
DRAWING TITLE:	TOP T1 & T2 LAYER MAT SLAB REINFORCEMENT DETAILS		DRAWING NO.:
			R2

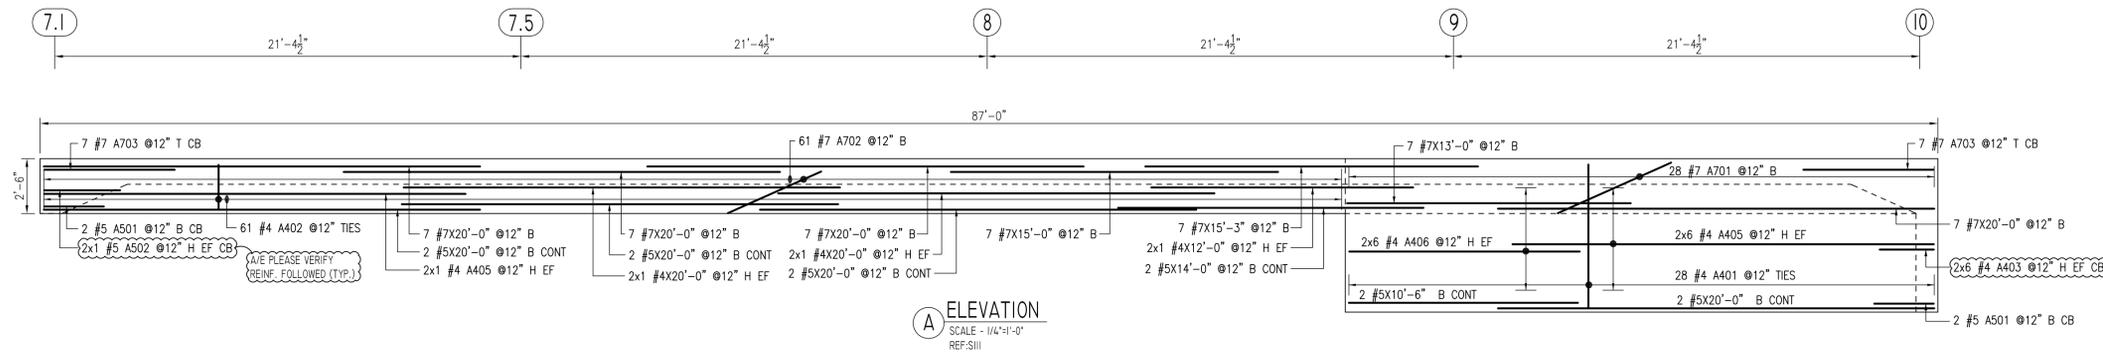

**A ELEVATION**  
SCALE - 1/4"=1'-0"  
REF.S11

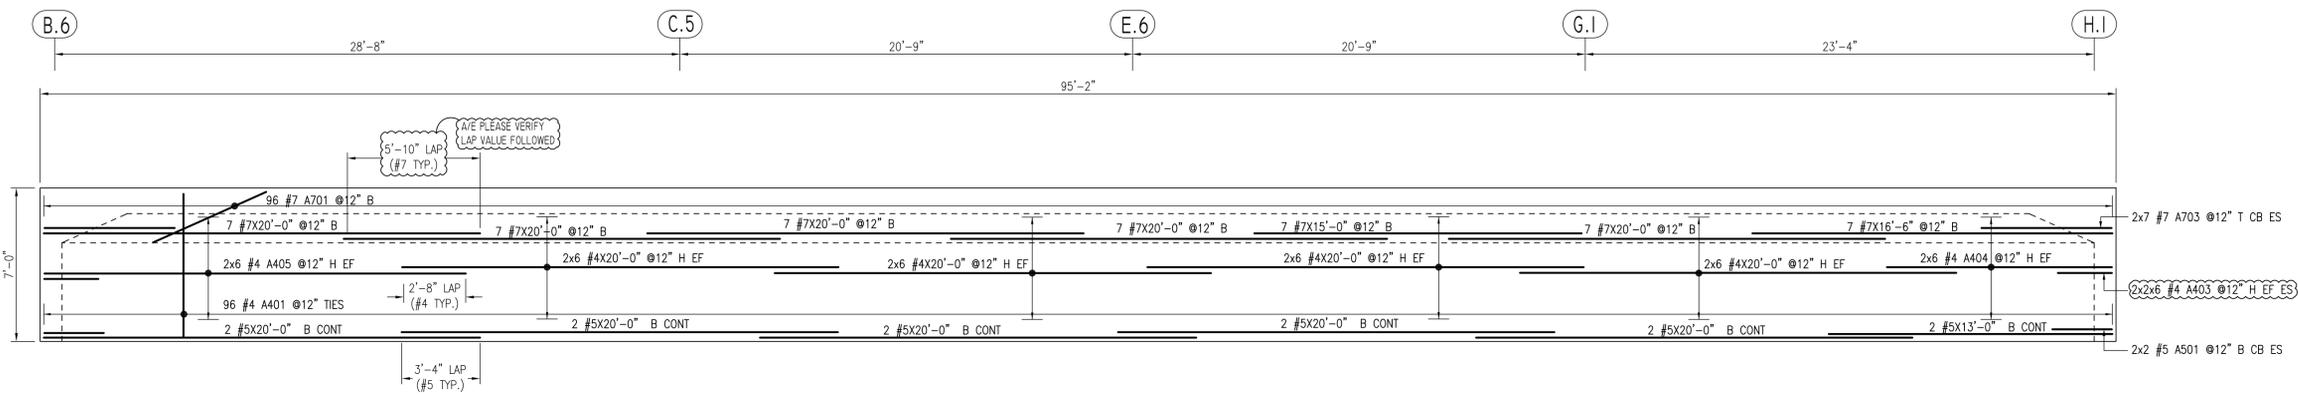


**B ELEVATION**  
SCALE - 1/4"=1'-0"  
REF.S11



**KEY PLAN**  
SCALE - NTS  
REF.S11

Release Code: R3

Bar Mark	Qty	Size	Total length	Type	A'	B'	C'	D'	E'	F'	G'	H'	I'	J'	K'	L'	M'	N'
A401	124	#4	57'12"	4 1/2"	7'	67'	8'	67'			4 1/2"							
A402	61	#4	61'12"	4 1/2"	7'	21'	7'	21'			4 1/2"							
A403	36	#4	50'0"		26'	26'												
A404	12	#4	10'0"	2	8'	10'4"												
A405	26	#4	20'0"	2	8'	19'4"												
A406	12	#4	11'3"	2	8'	10'7"												
A501	8	#5	56'0"		29'	29'												
A502	2	#5	70'0"		36'	36'												
A701	124	#7	75'1"	10'	59'						10'							
A702	61	#7	65'1"	10'	49'						10'							
A703	28	#7	12'0"	17	60'													

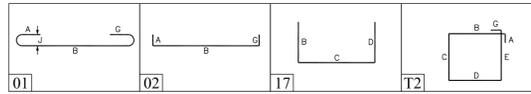

**LAP SCHEDULE**  
4000 PSI

SIZE	TOP	OTHERS
#3	24"	19"
#4	32"	25"
#5	40"	31"
#6	48"	37"
#7	70"	54"
#8	80"	62"
#9	91"	70"
#10	102"	79"
#11	115"	87"

PLEASE VERIFY THE LAP SCHEDULE FOLLOWED

**TYPICAL REINFORCING BAR CLEARANCE TABLE**

LOCATION	MIN. COVER
FOOTINGS AGAINST EARTH	3" CLR
WALLS INTERIOR FACE	3" CLR
WALLS EXTERIOR FACE	2" CLR
SLAB TOP	2" CLR
SLAB BOTTOM	3" CLR

PLEASE VERIFY THE CLEARANCE FOLLOWED

**ALL BARS IN THIS DRAWING  
ASTM A615 GRADE 60  
BLACK UNCOATED**

REVISION MARK	REVISION DETAILS	DATE
0	FOR APPROVAL	02/25/2020

**Abbreviations:**  
 IF=Inside Face  
 OF=Outside Face  
 EF=Each Face  
 DWL=Dowel  
 V=Vertical  
 H=Horizontal  
 C-B=Corner Bar  
 S-DWL=Slab Dowel  
 E-W=Each Way  
 B-BOT=Bottom  
 T=Top  
 MDWL=Masonry Dowel  
 B-B=Bond Beam  
 A.L.T.=Alternate  
 Approx.=Approximate


**OPNG=Opening**  
 BAL=Balance  
 BTW=Between  
 CJ=Construction Joint  
 CLR=CLEARANCE  
 CMU=Concrete Masonry Unit  
 CONT=Continuous  
 EA=Each  
 Elev.=Elevation  
 EMB=Embedment  
 SW=Short Way  
 LW=Long Way  
 (BL)=Black Bar  
 (EP)=Epoxy Bar  
 (GA)=Galvanized

**NOTICE**


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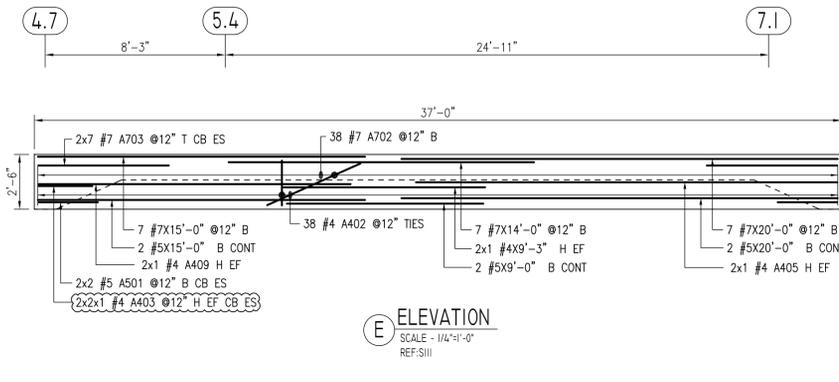
PROJECT	B&M MEATS		
LOCATION	WILMINGTON, DELAWARE		
ARCHITECT	-		
ENGINEER	DUMACK ENGINEERING		
CUSTOMER	JAR EXCAVATING		
DRAWN BY:	DATE:	REVIEWED BY:	JOB NO.
PTJ/MRS	02/25/20	T/L	20017
DRAWING TITLE:	FOUNDATION ELEVATION A-B REINFORCEMENT DETAILS		DRAWING NO.: R3




**C ELEVATION**  
SCALE - 1/4"=1'-0"  
REF: S11

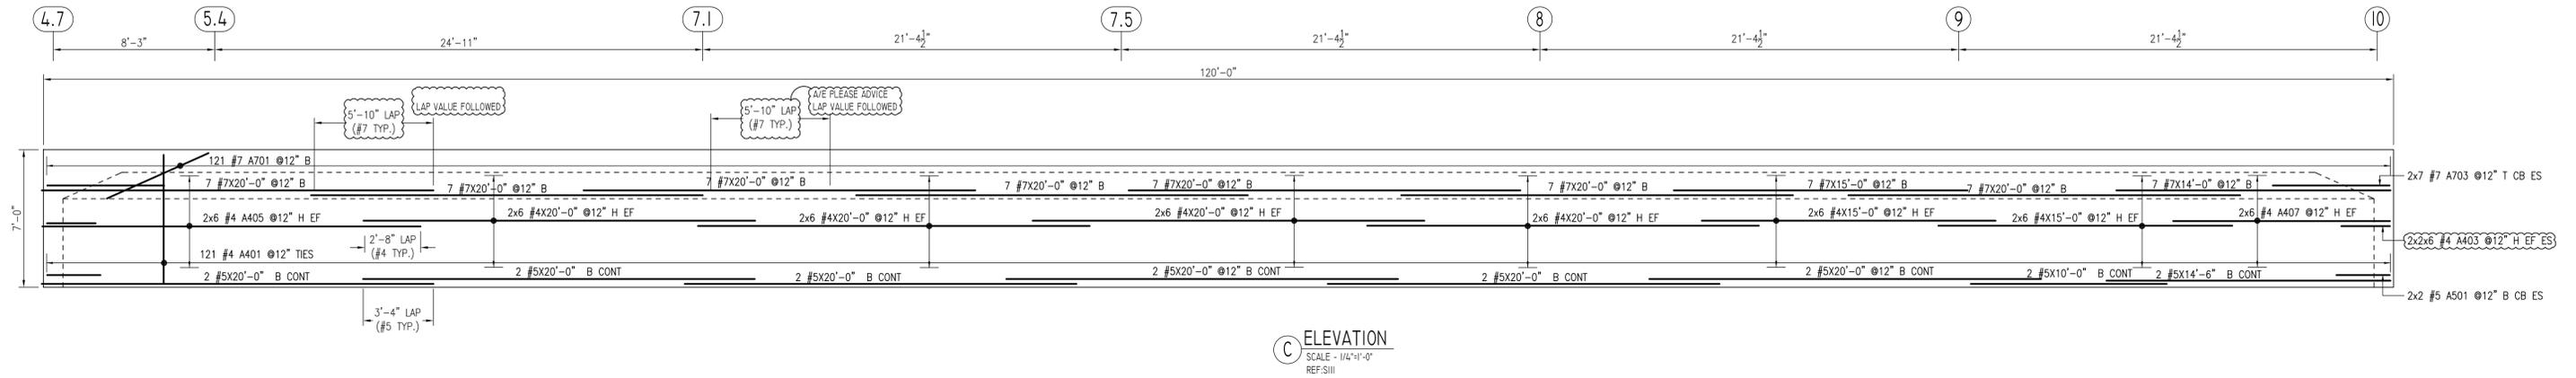


**D ELEVATION**  
SCALE - 1/4"=1'-0"  
REF: S11

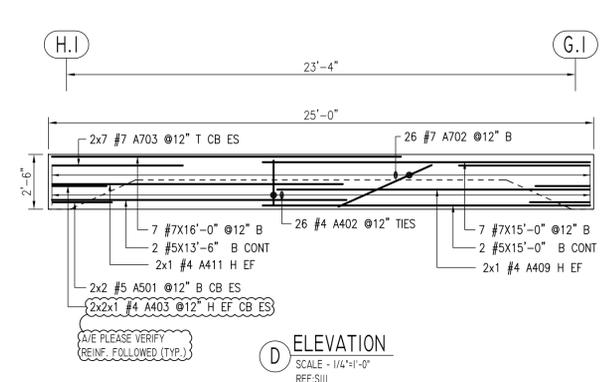

**E ELEVATION**  
SCALE - 1/4"=1'-0"  
REF: S11

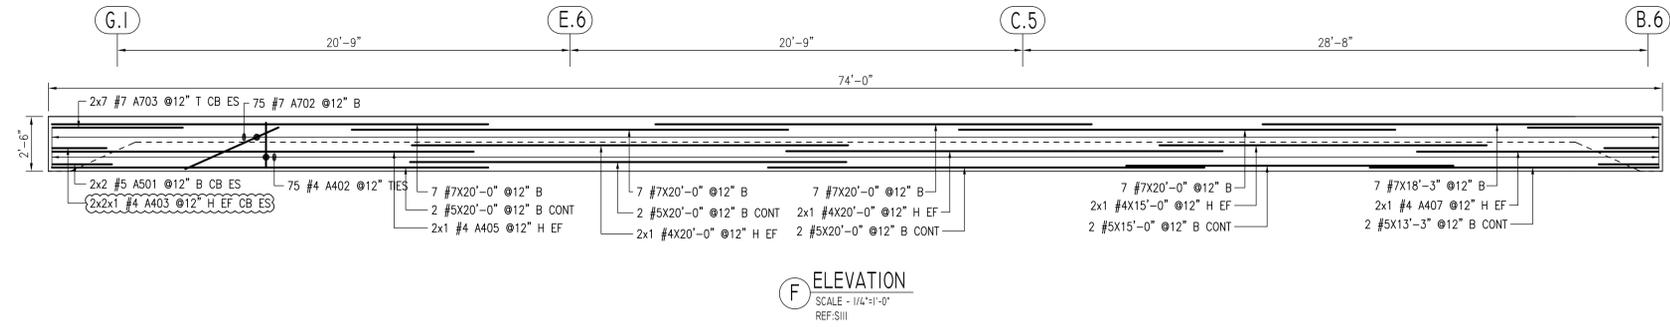


**F ELEVATION**  
SCALE - 1/4"=1'-0"  
REF: S11

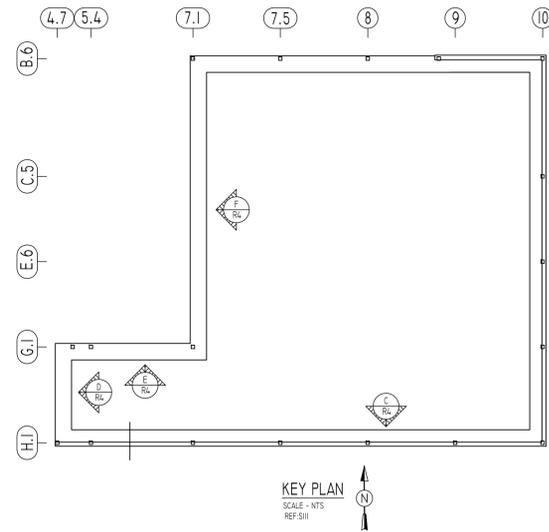

**KEY PLAN**  
SCALE - NTS  
REF: S11

Release Code: R4

BENDING DETAILS.														
Bar Mark	Qty	Size	Total Length	Type	'A'	'B'	'C'	'D'	'E'	'F'	'G'	'H'	'J'	'K'
A401	12	#4	15' 12"	L 1/2"	7"	6' 7"	8"	6' 7"		4 1/2"				
A402	139	#4	6' 11"	L 1/2"	7"	2' 11"	7"	2' 11"		4 1/2"				
A403	36	#4	5' 0"	T		2' 6"	2' 6"							
A405	16	#4	20' 0"	2	8"	19' 4"								
A407	14	#4	11' 9"	2	8"	11' 1"								
A409	4	#4	15' 0"	2	8"	14' 4"								
A411	2	#4	14' 0"	2	8"	13' 4"								
A501	16	#5	5' 6"	T		2' 9"	2' 9"			10"			7"	
A701	12	#7	7' 5"	1	10"	5' 9"				10"			7"	
A702	139	#7	6' 5"	1	10"	4' 9"				10"			7"	
A703	16	#7	12' 0"	T		6' 0"	6' 0"							

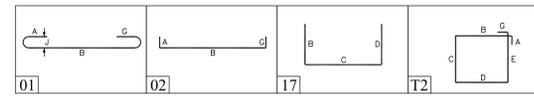

TYPICAL REINFORCING BAR CLEARANCE TABLE	
LOCATION	MIN. COVER
FOOTINGS AGAINST EARTH	3" CLR
WALLS INTERIOR FACE	3" CLR
WALLS EXTERIOR FACE	2" CLR
SLAB TOP	2" CLR
SLAB BOTTOM	3" CLR

A/E PLEASE VERIFY THE CLEARANCE FOLLOWED.

**ALL BARS IN THIS DRAWING  
ASTM A615 GRADE 60  
BLACK UNCOATED**

SIZE	4000 PSI	
	TOP	OTHERS
#3	24"	19"
#4	32"	25"
#5	40"	31"
#6	48"	37"
#7	70"	54"
#8	80"	62"
#9	91"	70"
#10	102"	79"
#11	113"	87"

A/E PLEASE VERIFY THE LAP SCHEDULE FOLLOWED.

**Abbreviations:**  
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 EF=Each Face  
 DWL=Dowel  
 V=Vertical  
 H=Horizontal  
 C.B.=Corner Bar  
 S.DWL=Slab Dowel  
 E.W.=Each Way  
 B.BOT=Bottom  
 T=Top  
 MDWL=Masonry Dowel  
 B.B.=Bond Beam  
 ALT.=Alternate  
 Approx.=Approximate

**OPNG=Opening**  
 BAL.=Balance  
 BTW=Between  
 C.=Construction Joint  
 CLR.=CLEARANCE  
 CMU=Concrete Masonry Unit  
 CONT.=Continuous  
 EA.=Each  
 Elev.=Elevation  
 EMB.=Embedment  
 SW.=Short Way  
 LW.=Long Way  
 (BL)=Black Bar  
 (EP)=Epoxy Bar  
 (GA)=Galvanized

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REVISION MARK	REVISION DETAILS	DATE
0	FOR APPROVAL	02/25/2020

PROJECT	B&M MEATS
LOCATION	WILMINGTON, DELAWARE
ARCHITECT	-
ENGINEER	DUMACK ENGINEERING
CUSTOMER	JAR EXCAVATING
DRAWN BY:	PTJ/MRS
DATE:	02/25/20
REVIEWED BY:	T/L
JOB NO.	20017
DRAWING TITLE:	FOUNDATION ELEVATION C-F REINFORCEMENT DETAILS
DRAWING NO.:	R4