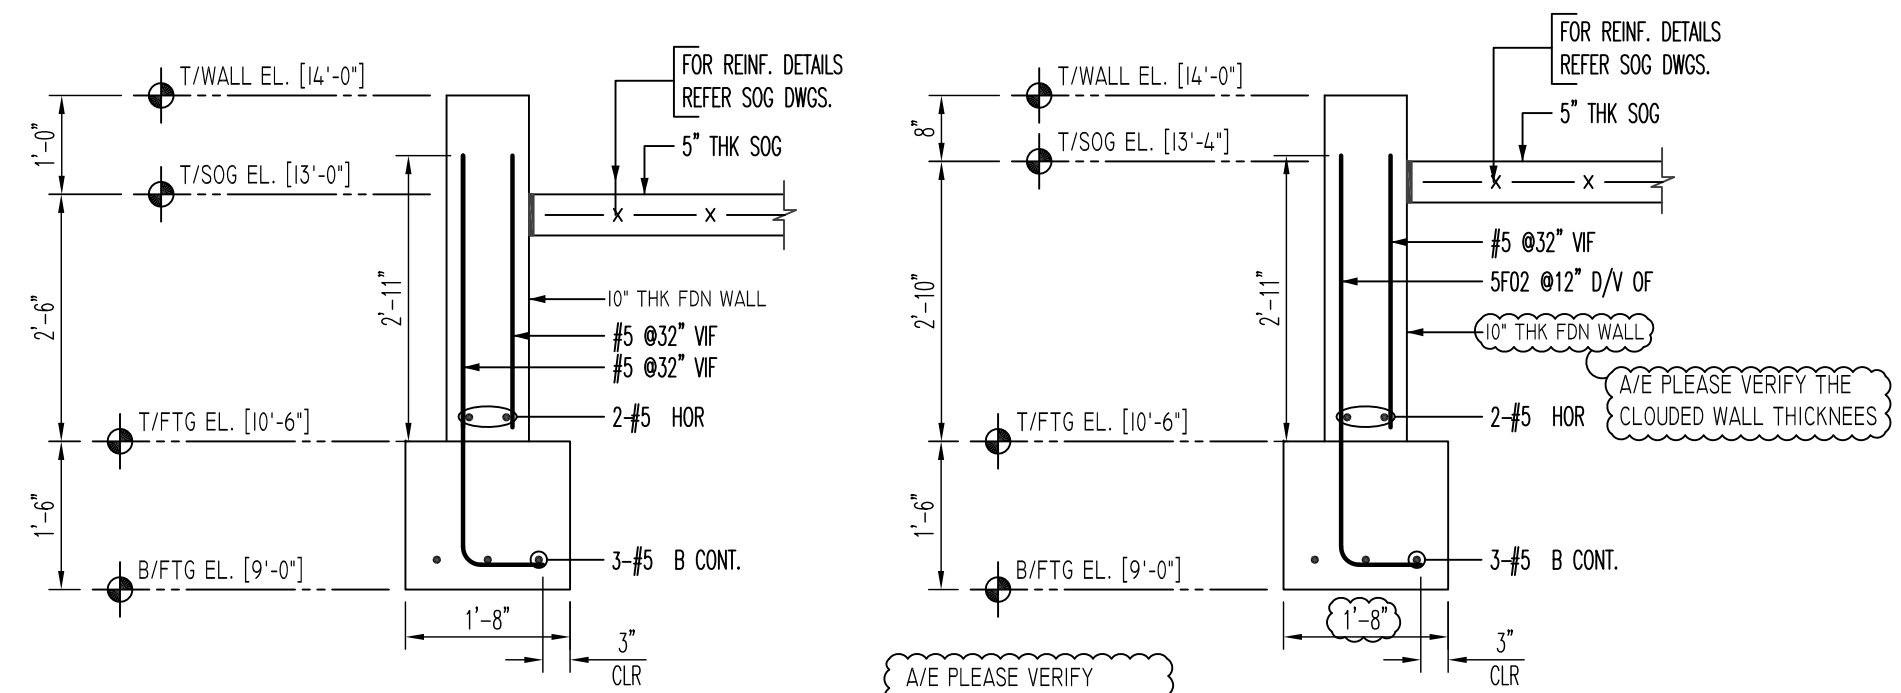


BUILDING-B WALL FOOTINGS REINFORCEMENT DETAILS
 SCALE: 1/8" = 1'-0"
 REF: S100 (DT.03/08/22)

LAP SCHEDULE		
SIZE	3000 PSI	
	TOP	OTHERS
#3	28"	22"
#4	37"	29"
#5	47"	36"
#6	56"	43"
#7	81"	63"
#8	93"	72"
#9	105"	81"
#10	118"	91"
#11	131"	101"

TYPICAL REINFORCING BAR CLEARANCE TABLE	
LOCATION	MIN. COVER
FOOTING TOP	3" CLR
FOOTING BOT & SIDES	3" CLR
WALL SIDES	2" CLR

**ALL BARS IN THIS DRAWING
 ASTM A615 GRADE 60
 BLACK UNCOATED**



SECTION 1
 SCALE: 1/2" = 1'-0"
 REF: I82/S600 (DT.02/22/22)

SECTION 2
 SCALE: 1/2" = 1'-0"
 REF: I82/S600 (DT.02/22/22)

- Abbreviations:**
 I.F. = Inside Face
 O.F. = Outside Face
 E.F. = Each Face
 DWL = Dowel
 V = Vertical
 H = Horizontal
 C.B. = Corner Bar
 S.DWL = Slab Dowel
 E.W. = Each Way
 B/BOT = Bottom
 T = Top
 MDWL = Masonry Dowel
 B.B. = Bond Beam
 ALT. = Alternate
 Approx. = Approximate
- OPNG = Opening**
 BAL = Balance
 BTW = Between
 CJ = Construction Joint
 CLR = CLEARANCE
 CMU = Concrete Masonry Unit
 CONT = Continuous
 EA = Each
 Elev. = Elevation
 EMB = Embedment
 SW = Short Way
 MDWL = Masonry Dowel
 B.B. = Bond Beam
 ALT. = Alternate
 Approx. = Approximate


NOTICE
 Shortages, improper fabrication or claims for any other reason must be reported to this company within a period of 15 days of delivery. This company reserves the right to field inspect prior to replacement or reconditioning of nonconforming material, and will not honor charges for work done in the field without specific authorization from this company.

REINFORCING STEEL PLACING DRAWINGS ONLY USE IN CONJUNCTION WITH CONTRACT DRAWINGS & SPECIFICATIONS. ELEVATIONS & DIMENSIONS SHOWN ON THIS DRAWING ARE FOR DETAILING PURPOSES ONLY AND SHOULD NOT BE USED FOR CONSTRUCTION UNLESS VERIFIED BY ENGINEER OR CONTRACTOR.

REVISION MARK	REVISION DETAILS	DATE
0	FOR APPROVAL	03/23/2022


PROJECT	MARINERS LANDING
LOCATION	60 MAPLE STREET, BRANFORD, CT
ARCHITECT	CHARLES GEORGIE ASSOCIATES
ENGINEER	CHARLES GEORGIE ASSOCIATES
CUSTOMER	CHERRY HILL INC

DRAWN BY:	DATE:	REVIEWED BY:	JOB NO.
GOW/MRS	03/23/22	T/L	22016
DRAWING TITLE:			DRAWING NO.:
BUILDING-B WALL FOOTINGS REINFORCEMENT DETAILS			R07

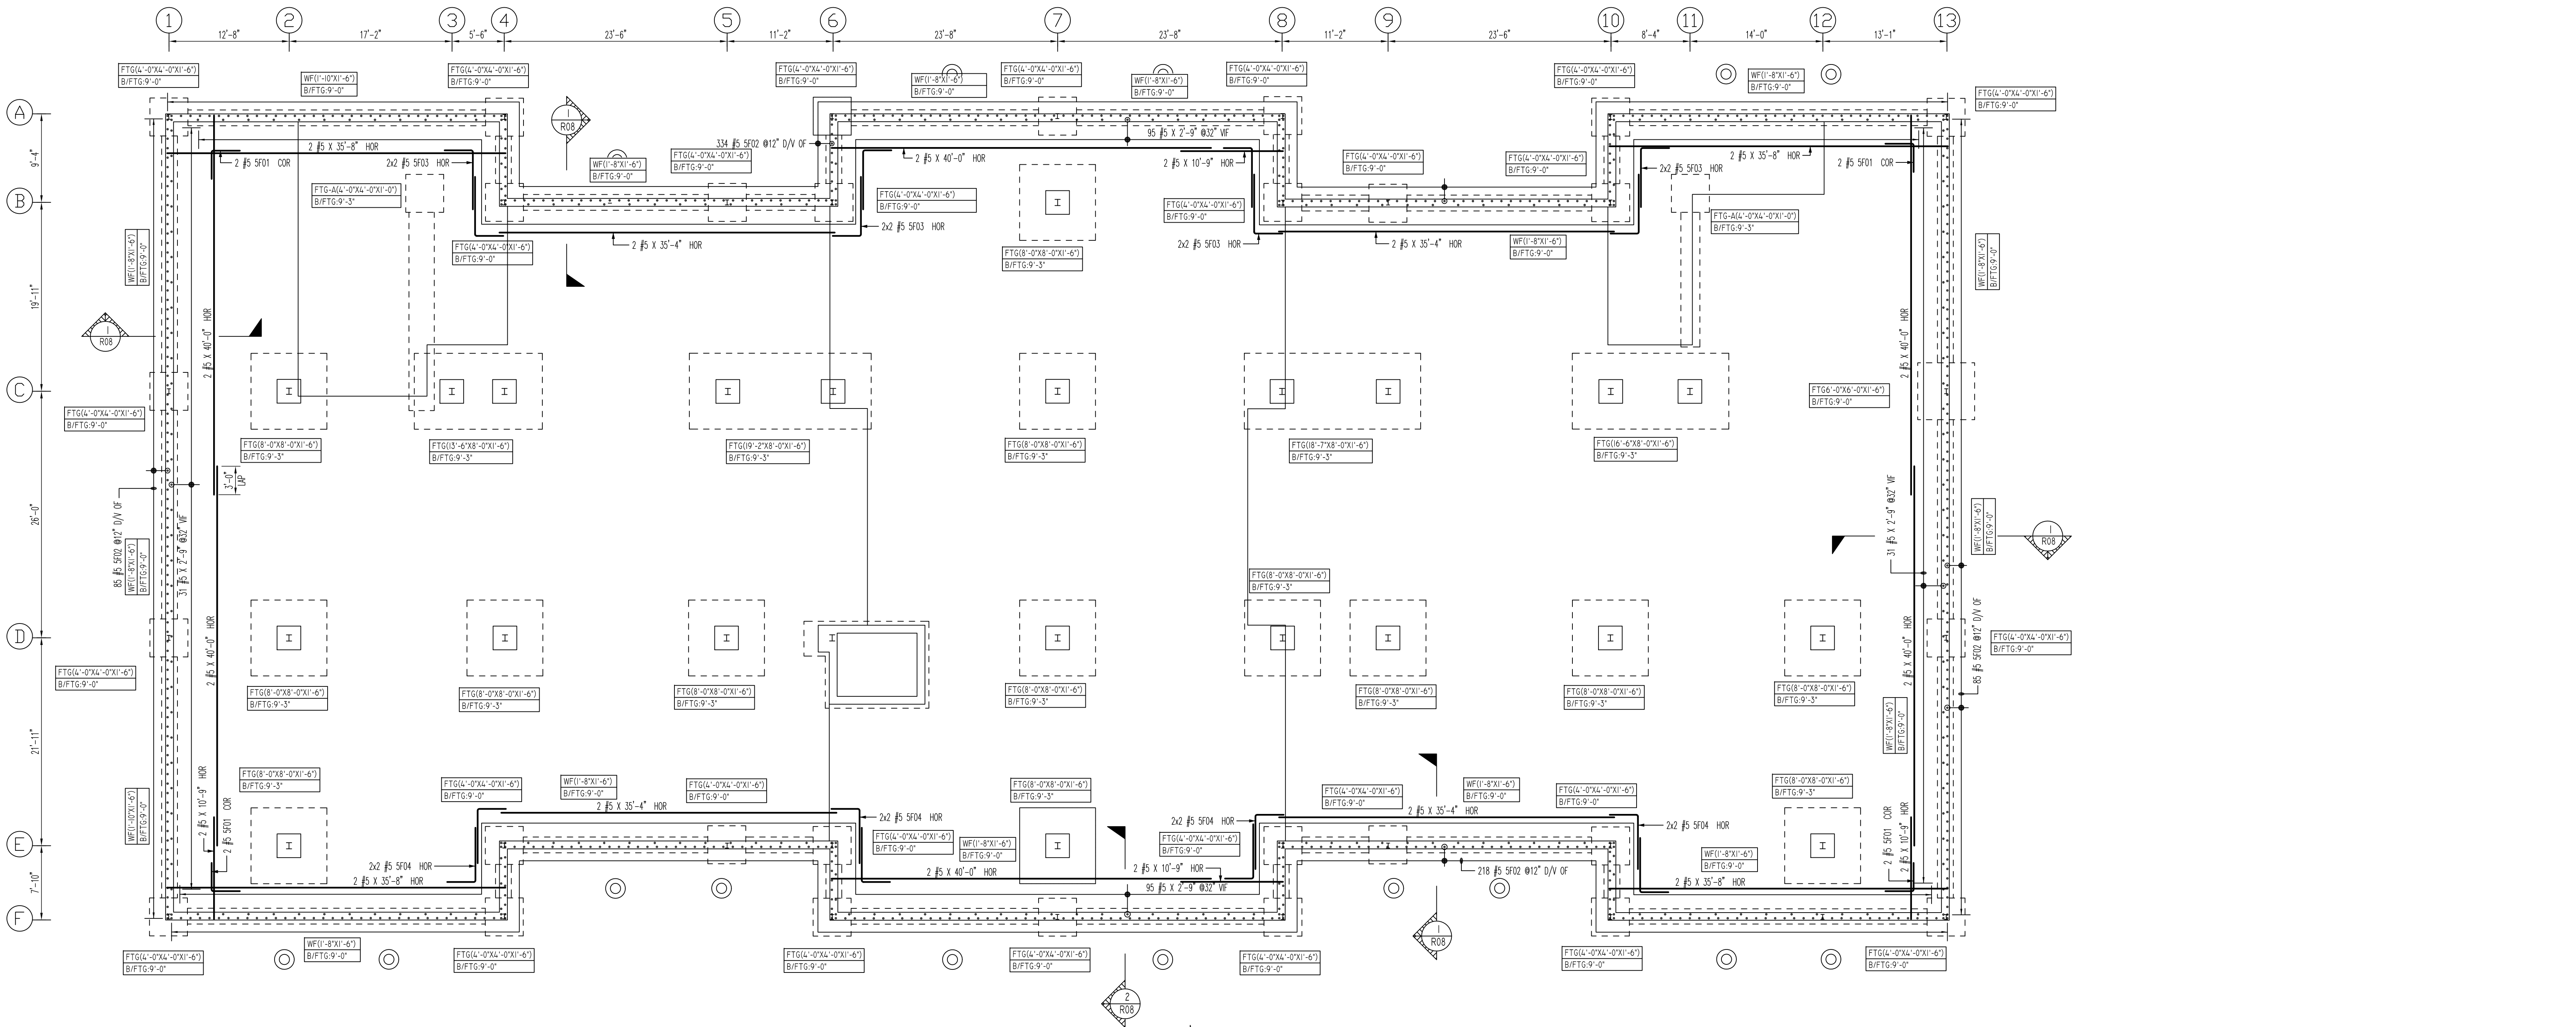


BUILDING-B FOUNDATION WALL REINFORCEMENT DETAILS

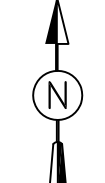SCALE: 1/8" = 1'-0"
REF-S100 (DT. 03/08/22)



Release Number: ROB

Bar Mark	Qty	Size	Total Length	Type	X	Y	Z	W	V	U	T	S	R	Q	P	O	N	M	L	K	J	I	H	G	F	E	D	C	B	A
5F01	8	#5	6'-0"	17																										
5F02	728	#5	5'-0"	2	0'-10"	4'-2"																								
5F03	18	#5	9'-3"	17																										
5F04	18	#5	6'-9"	17																										

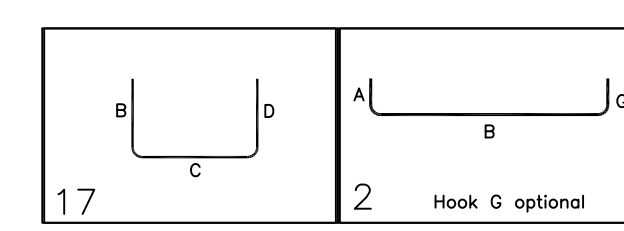


LAP SCHEDULE

SIZE	3000 PSI	
	TOP	OTHERS
#3	28"	22"
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TYPICAL REINFORCING BAR CLEARANCE TABLE

LOCATION	MIN. COVER
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**ALL BARS IN THIS DRAWING
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REVISION MARK	REVISION DETAILS	DATE
0	FOR APPROVAL	03/23/2022

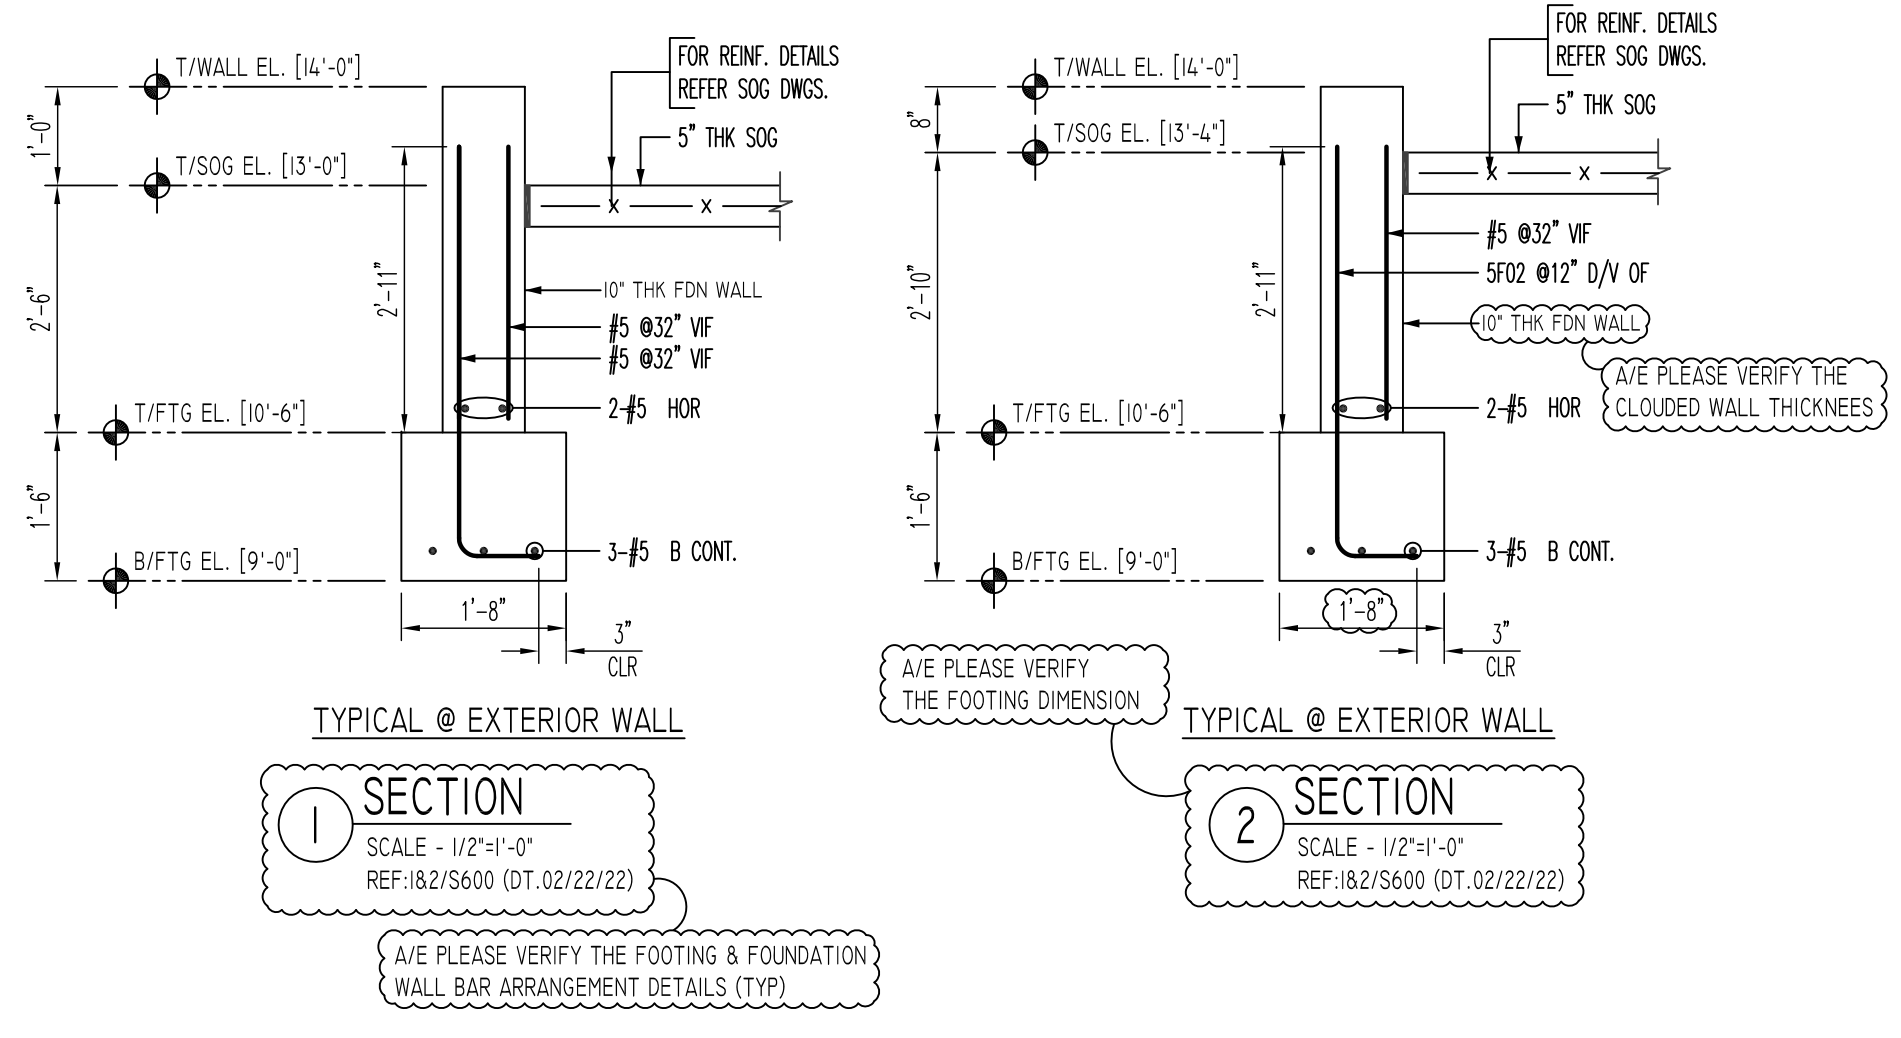PROJECT	MARINERS LANDING						
LOCATION	60 MAPLE STREET, BRANFORD, CT						
ARCHITECT	CHARLES GEORGIE ASSOCIATES						
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CUSTOMER	CHERRY HILL INC						
DRAWN BY:	GOW/MRS	DATE:	03/23/22	REVIEWED BY:	T/L	JOB NO.:	22016
DRAWING TITLE:							DRAWING NO.:
BUILDING-B FOUNDATION WALL REINFORCEMENT DETAILS							R08