




1 CONCRETE WALK
 REF:6/L-501
 SCALE: 1/2" = 1'-0"

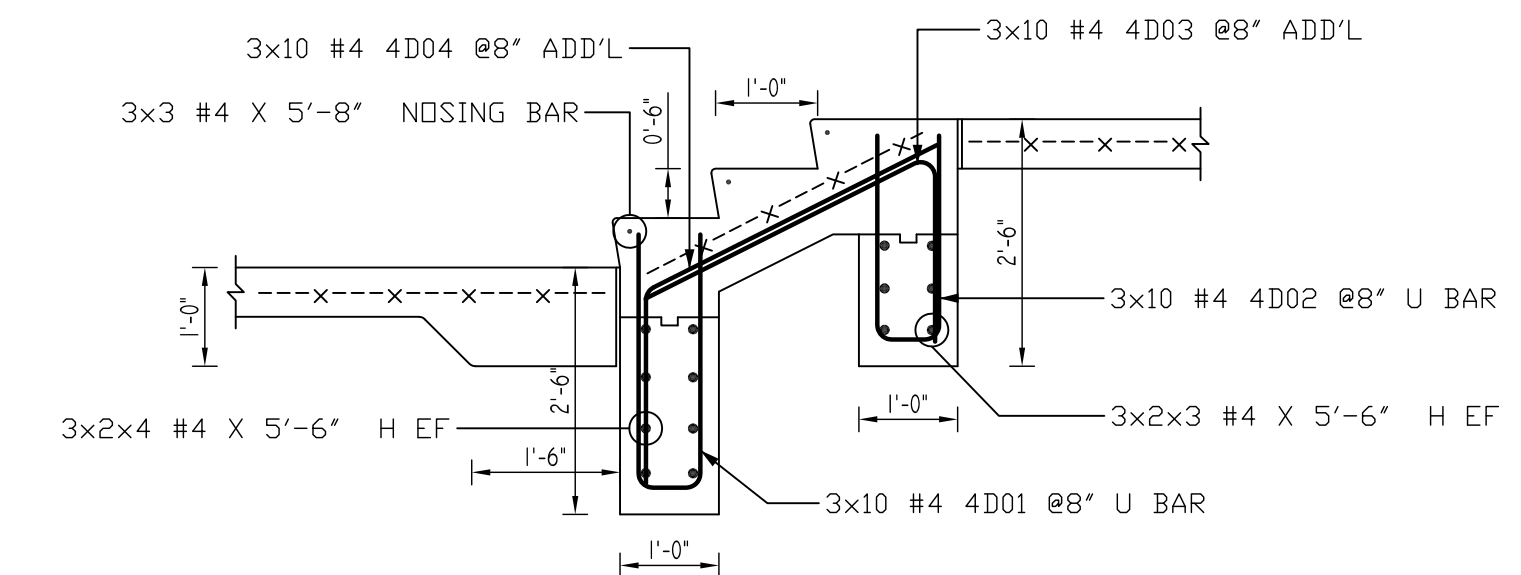

2 CONCRETE STEP
 REF:6/L-501
 SCALE: 1/2" = 1'-0"
 (@3 LOCATIONS)

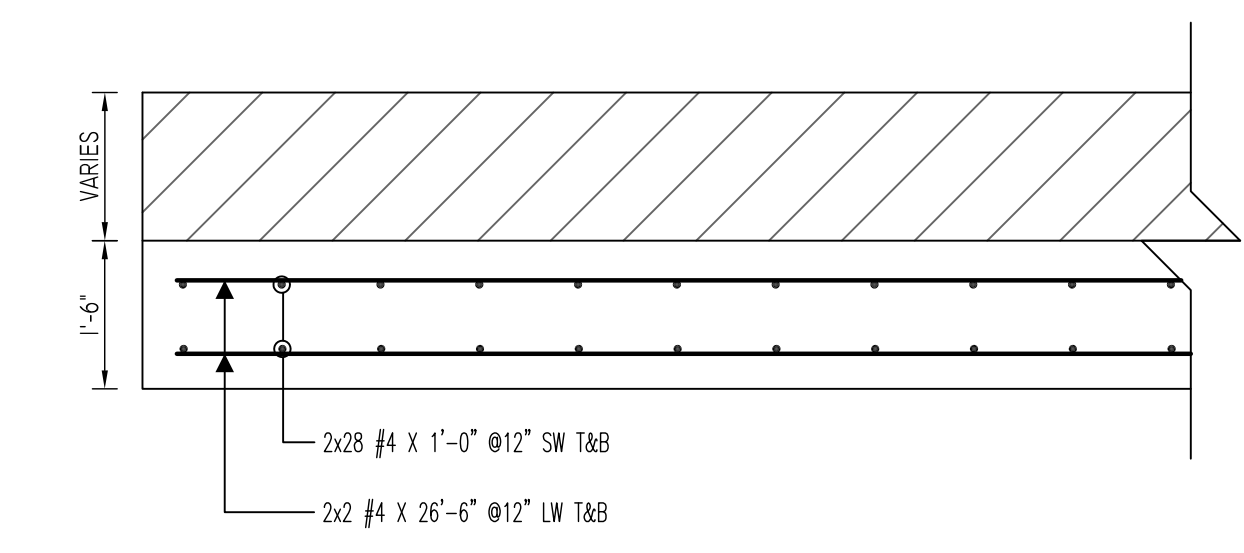


(@ STONE WALL)
3 CONCRETE BASE
 REF:4/L-504
 SCALE: 1/2" = 1'-0"

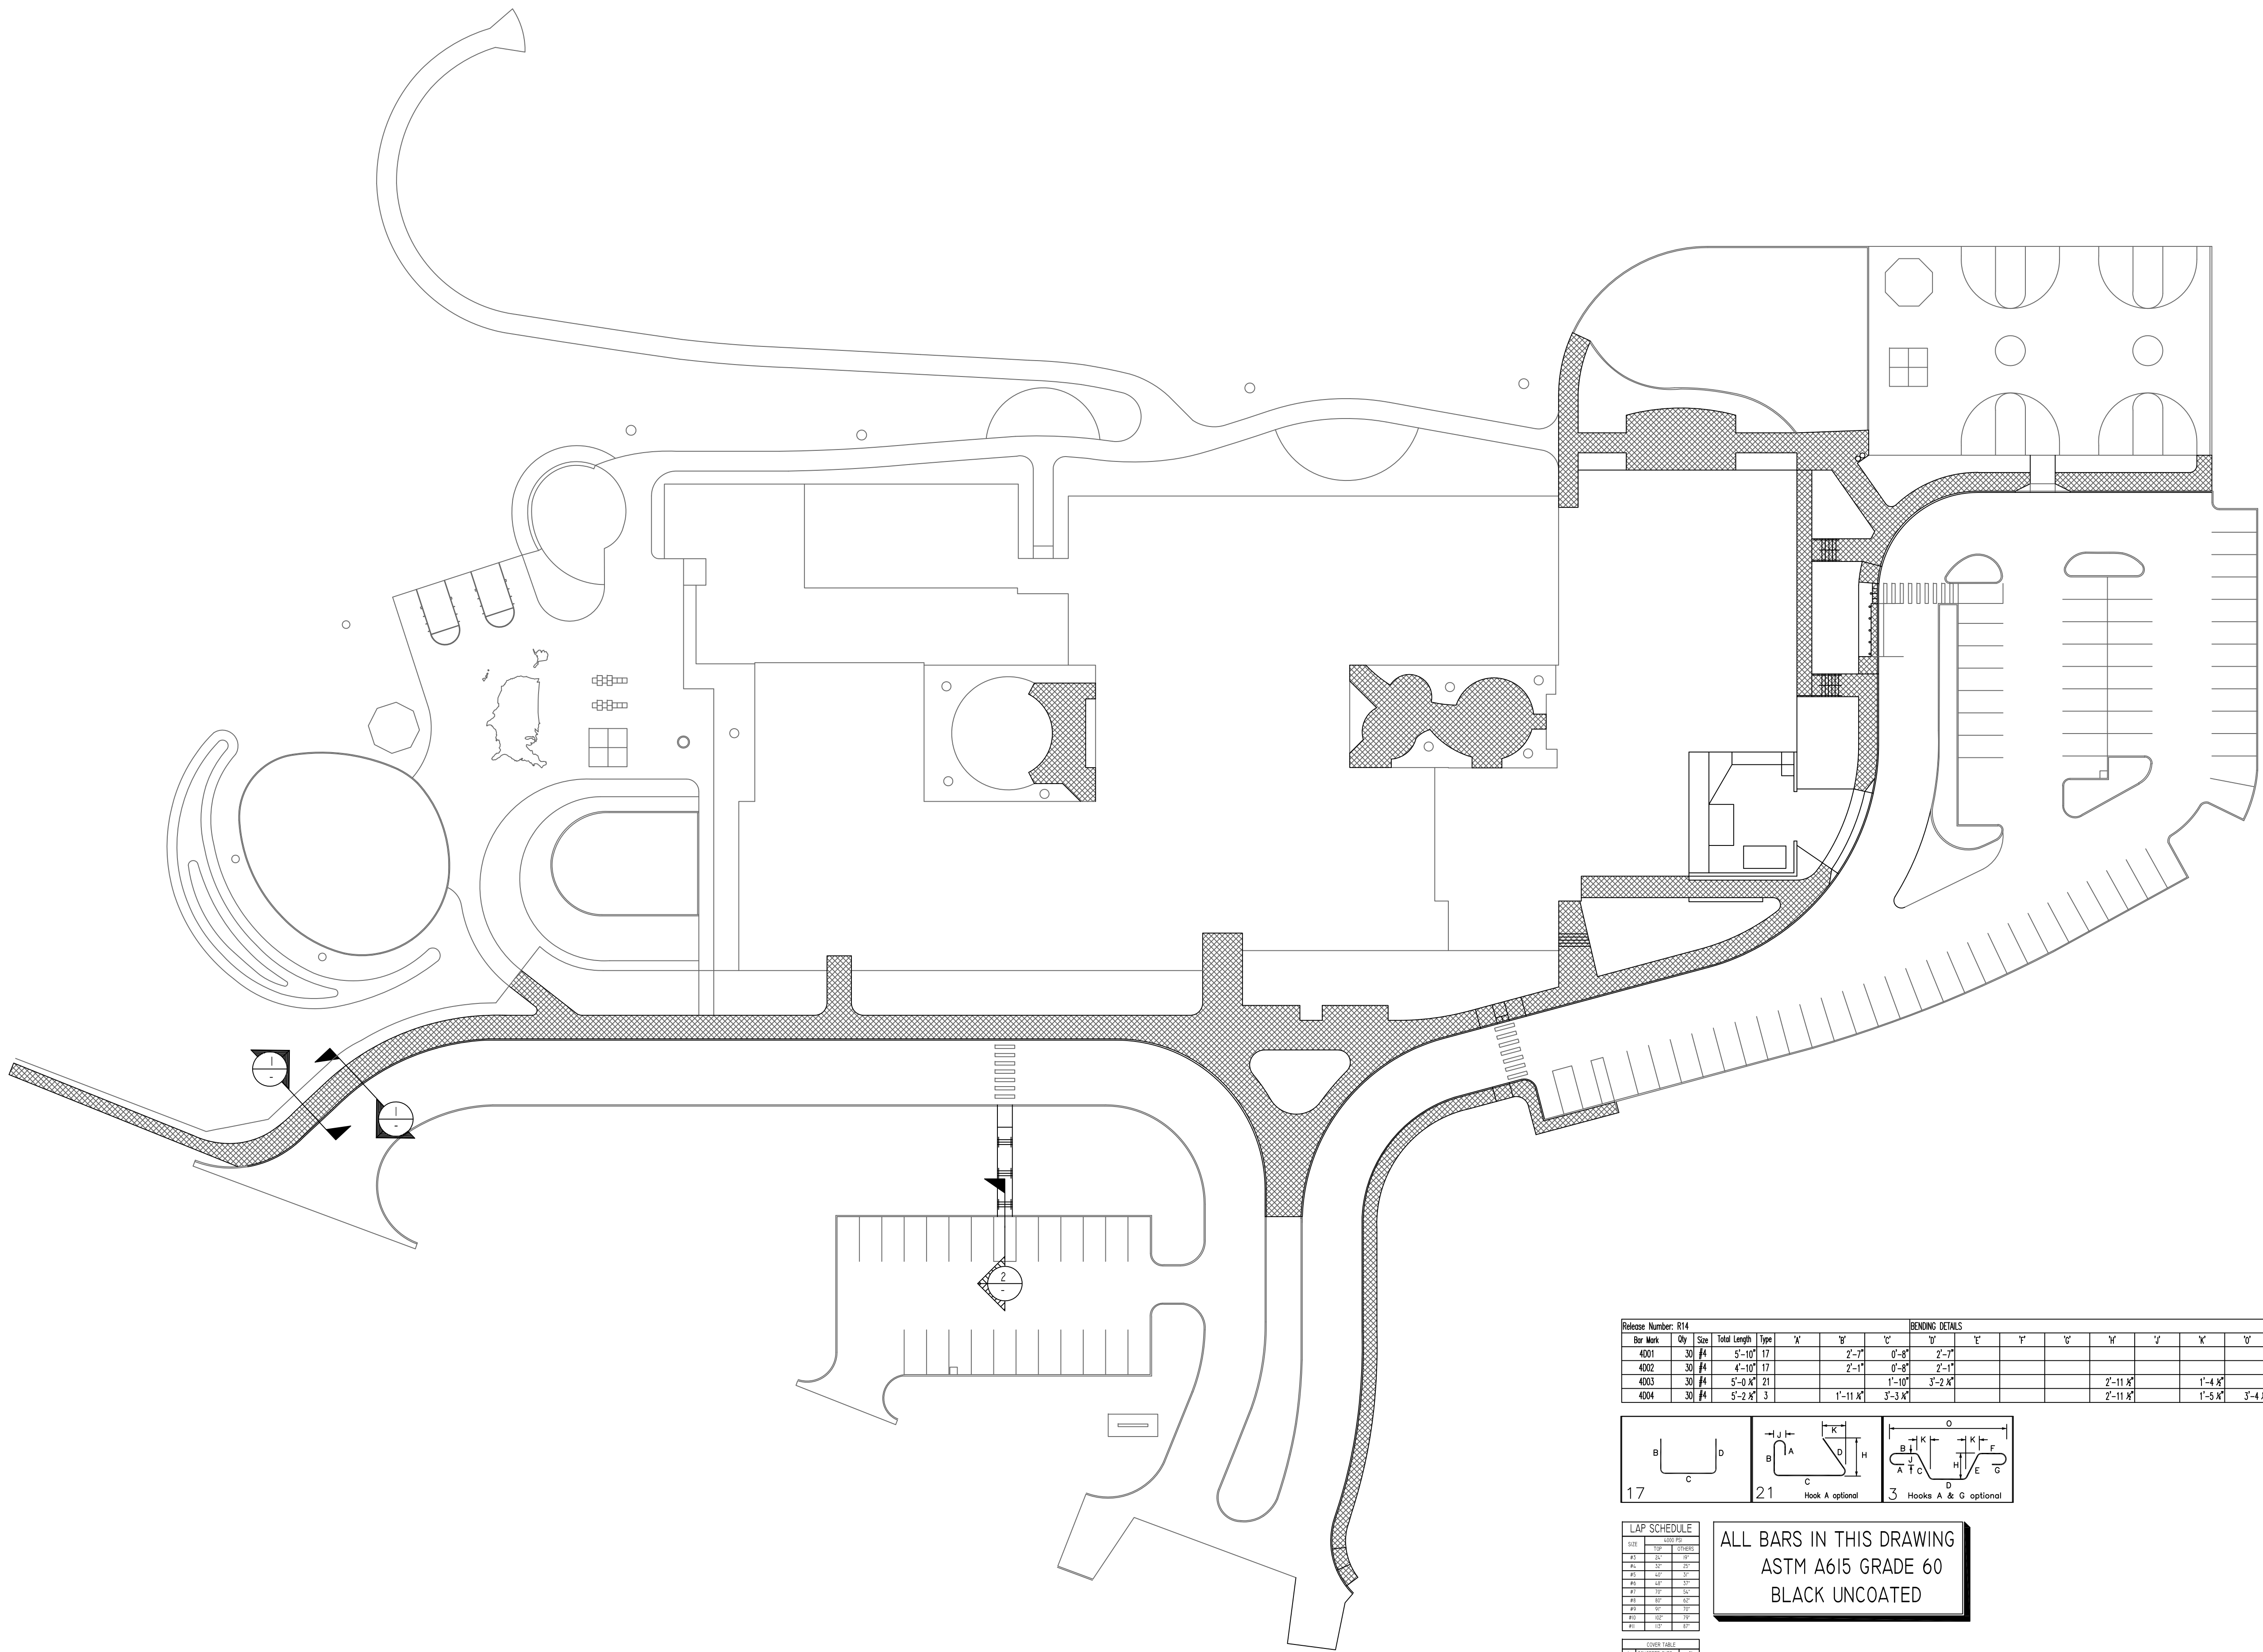

Release Number: R14

Bar Mark	Qty	Size	Total Length	Type	X	Y	Z	Y'	Y''	Y'''	Y''''	Y'''''	Y''''''	Y'''''''
4001	30	#4	5'-10"	17		2'-7"	0'-8"	2'-7"						
4002	30	#4	4'-10"	17		2'-1"	0'-8"	2'-1"						
4003	30	#4	5'-0"	21		1'-10"	0'-8"	1'-10"		2'-11"		1'-4"		
4004	30	#4	5'-2"	3		1'-11"	0'-8"	1'-11"		2'-11"		1'-5"	3'-4"	

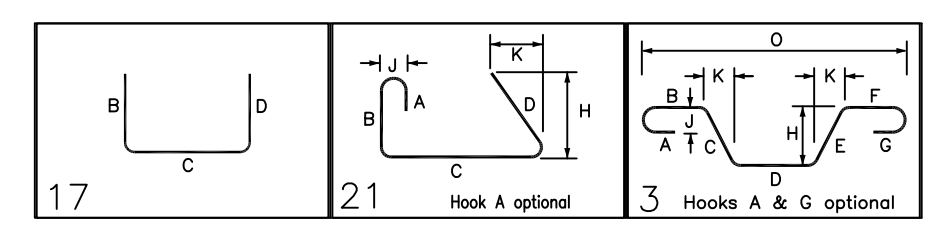

LAP SCHEDULE

Bar Mark	Qty	Size	Total Length	Type
17	30	#4	5'-10"	17
21	30	#4	4'-10"	17
3	30	#4	5'-0"	21
4	30	#4	5'-2"	3

ALL BARS IN THIS DRAWING
 ASTM A615 GRADE 60
 BLACK UNCOATED

SITWORK REINFORCEMENT DETAILS
 REF:L-121 & L-131
 N.T.S.

MESH DETAILS

S. NO	ELEMENT	MESH SIZE	SHEETS	AREA	REMARK
1	5" THK SLAB ON GRADE	6x6 - W2.9XW2.9 WWF	550	20300 SQ.FT	5'-0" X 10'-0" SHEET SIZE (35% LAP ADDED)

ACCESSORIES DETAILS

S. NO	ELEMENT	DESCRIPTION	PCS	LFT	REMARK
1	5" THK SOG	3" HT CHC @4'-0" C/C	-	1300	FOR MESH SUPPORT (@ BOTTOM)

Abbreviations:
 I.F.=Inside Face
 O.F.=Outside Face
 E.F.=Each Face
 DWL=Dowel
 V=Vertical
 H=Horizontal
 C.B.=Corner Bar
 S.DWL=Slab Dowel
 E.W.=Each Way
 B/BOT.=Bottom
 T=Top
 MDWL=Masonry Dowel
 B.B.=Bond Beam
 ALT.=Alternate
 Approx.=Approximate

OPNG=Opening
 BAL=Balance
 BTW=Between
 CJ=Construction Joint
 CLR=CLEARANCE
 CMU=Concrete Masonry Unit
 CONT.=Continuous
 EA.=Each
 Elev.=Elevation
 EMB=Embedment
 SW=Short Way
 LW=Long Way
 (BL)=Black Bar
 (EP)=Epoxy Bar
 (GA)=Galvanized

NOTICE

Shortages, improper fabrication or claims for any other reason must be reported to this company within a period of 15 days of delivery. This company reserves the right to field inspect prior to replacement or reconditioning of nonconforming material, and will not honor charges for work done in the field without specific authorization from this company.

REINFORCING STEEL PLACING DRAWINGS ONLY USE IN CONJUNCTION WITH CONTRACT DRAWINGS & SPECIFICATIONS. ELEVATIONS & DIMENSIONS SHOWN ON THIS DRAWING ARE FOR DETAILING PURPOSES ONLY AND SHOULD NOT BE USED FOR CONSTRUCTION UNLESS VERIFIED BY ENGINEER OR CONTRACTOR.

REVISION MARK	REVISION DETAILS	DATE
0	FOR APPROVAL	08/09/2022

PROJECT	LATIMER LANE SCHOOL RENOVATION
LOCATION	33 MOUNTAIN VIEW DRIVE WEATOGUE, CT 06089
ARCHITECT	TECTON ARCHITECTS
ENGINEER	-
CUSTOMER	-

DRAWN BY:	DATE:	REVIEWED BY:	JOB NO.
GOW/MRS	08/09/22	T/L	22065
DRAWING TITLE:			DRAWING NO.:
SITWORK REINFORCEMENT DETAILS			R14