



PLAN OF GENERATOR PAD REINFORCEMENT DETAILS

REF:C-002 SCALE: 1/2" = 1'-0"

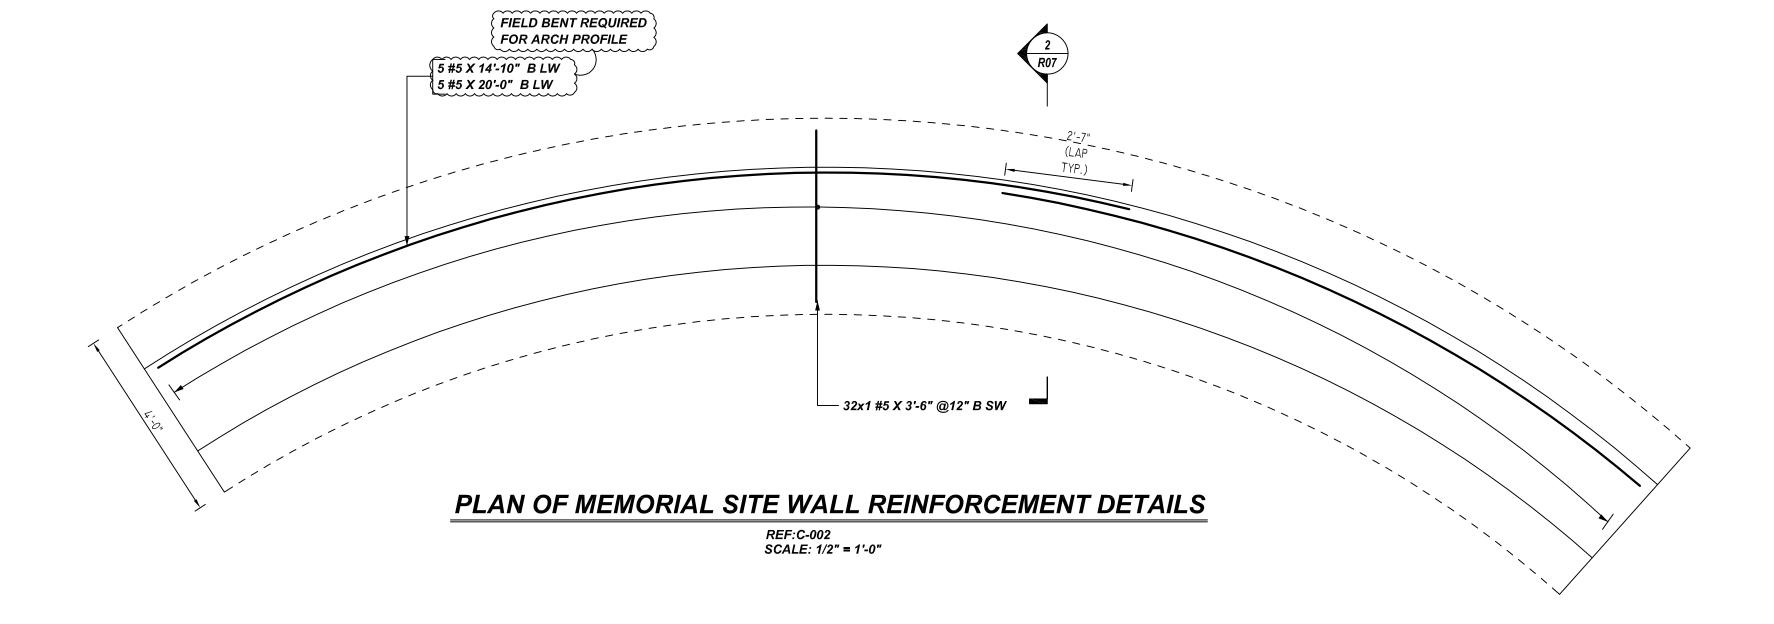


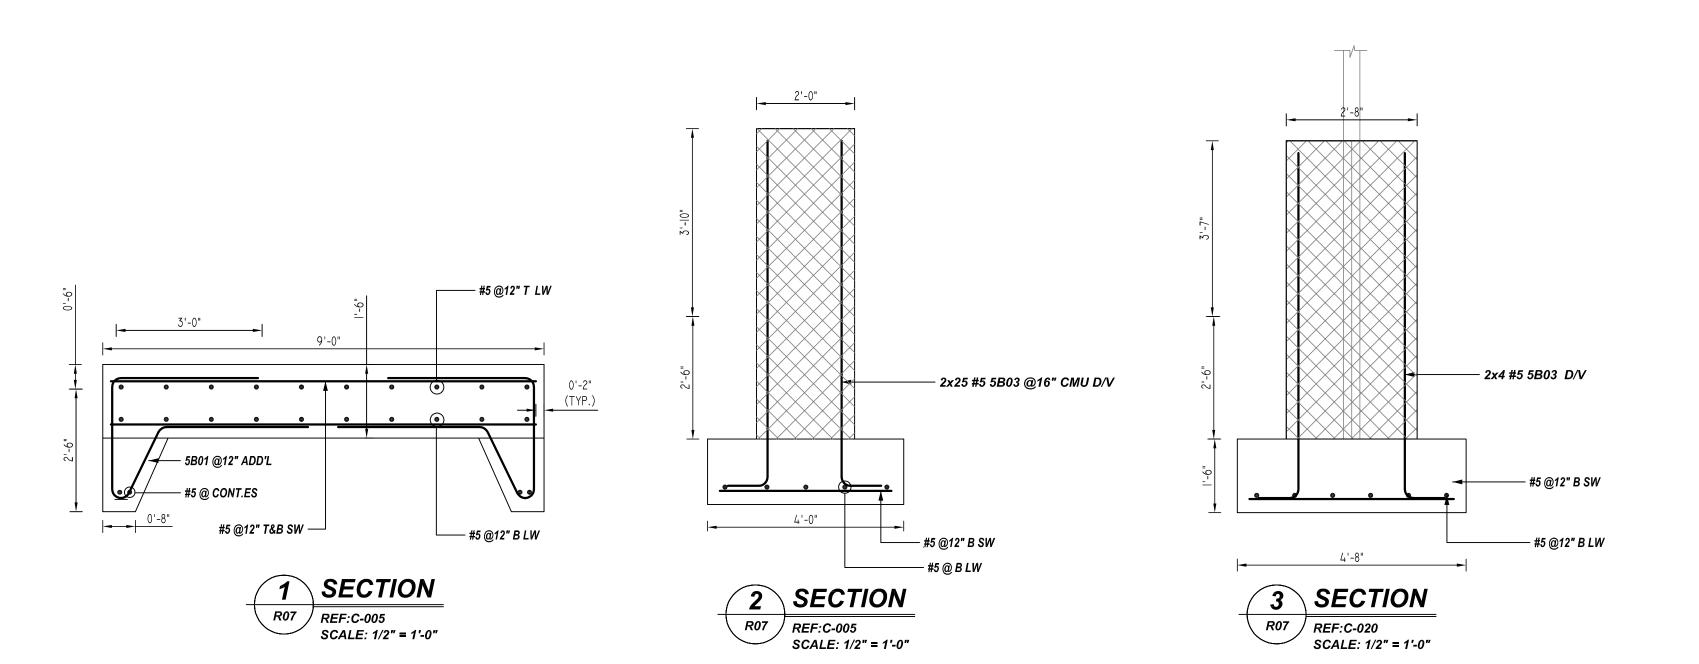

NOTICE
SHORTAGES, IMPROPER FABRICATION OR CLAIMS FOR ANY OTHER REASON MUST BE REPORTED TO THIS COMPANY WITHIN 10 DAYS FROM ORIGINAL DELIVERY. THIS COMPANY ALSO RESERVES THE RIGHT TO FIELD INSPECT MATERAILS PRIOR TO REPLACEMENT OR RECONDITIONING OF MATERIALS AND WILL NOT BE LIABLE FOR CHARGES FROM WORK DONE IN THE FIELD WITHOUT PRIOR AUTHORIZATION FROM THIS COMPANY.

REINFORCING STEEL PLACING DRAWING ONLY.USE IN CONJUCTION WITH CONTRACT DRAWINGS & SPECIFICATIONS. ELEVATIONS & DIMENSIONS SHOWN ON DRAWING ARE FOR DETAILING PURPOSES ONLY AND SHOULD NOT BE USED FOR CONSTRUCTION UNLESS VERIFIED BY ENGINEER OR CONTRACTOR.

_																	
Release Number: R07							BENDING DETAILS										
ĺ	Bar Mark	Qty	Size	Total Length	Туре	'A'	'B'	'C'	'D'	'E'	'F'	'G'	'H'	'J'	'K'	'0'	'R'
[5B01	83	# 5	10'-5 ¾"	R32	3'-0"	2'-6"	0'-4"	1'-7 ¾"			3'-0"	1'-6"		0'-8 ¼"		
Ī	5B02	8	# 5	10'-4"	2	0'-10"	8'-8"					0'-10"					
Ī	5B03	58	# 5	7'-10 ¾"	2	0'-10"	7'-0 ¾"										

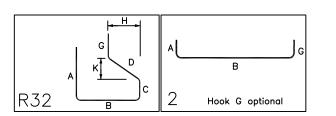

LAP SCHEDULE


4000 PSI (CLASS-B) CASE - 1 Per ACI :318 (12.2.2)

Per ACI :318 (12.2.2)									
	LENGTHS								
BAR#	TOP	OTHERS							
#3	2'-0"	1'-7"							
#4	2'-8"	2'-1"							
#5	3'-4"	2'-7"							
#6	4'-0"	3'-1"							
#7	5'-10"	4'-6"							
#8	6'-8"	5'-2"							
#9	7'-7"	5'-10"							
#10	8'-6"	6'-7"							
#11	9'-5"	7'-3"							

ALL TOP BARS ARE DEFINED AS HORIZ BARS WITH MORE THAN 12" OF CONCRETE BELOW BARS.

ALL BARS IN THIS DRAWING ASTM A615 GRADE 60 **BLACK UNCOATED**


RANCE TABLE
MIN. COVER
3" CLR
2" CLR
2" CLR

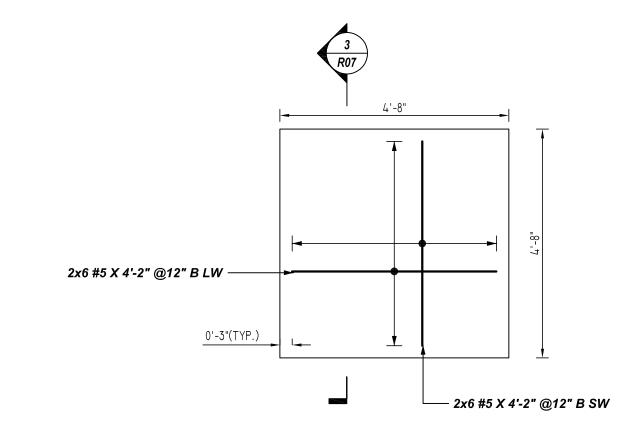

PLAN OF PLAZA LIGHTED REINFORCEMENT DETAILS

REF:C-002 SCALE: 1/2" = 1'-0" 2 LOCATIONS


REB	AR GRA	DE 60 A	ASTN	/ A-6	15				
	S USED	ABBREVIAT ADD. = Additi	TONS onal	BAR MA	ARK SIZE ALENT				
TOP BARS #3 24" #4 32" #5 40" #6 48" #7 70" #8 80" #9 91" #10 102" #11 113" #14	000 psi UNO OTHER BARS #3	B.O.W. = Botton C.B. = Corne DIAG. = Diago D.O. = Door o DWLS. = Dowe E.F. = Each E.S. = Each FTG. = Footin F.F. = Far Fa HORIZ. = Horizo I.F. = Inside INTERS= Inters L.W. = long V N.F. = Near I O.F. = Outsid S.W. = Short T&B = Top & T.O.W. = Top o Trans. = Trans VERT. = Vertic	r Bars nal Opening Is Face Side Way ng Contal Face Face Face de Face Way Bottom f Wall verse	#3 #4 #5 #6 #7 #8 #9 #10 #11	#10 #13 #16 #19 #22 #25 #29 #32 #36		SITE WO	OF HYATTSV ORK REINFORCEMENT DI STREET HYATTSV	ETAILS
			•			DESIGNER:	COLUI	MBIA ENGINEERING	
0 06.14.2	2 APPROVAL						DATE	JOB NO	SHEET NO.
REV NO DATE	SENT FOR	REV NO	DATE	SENT	FOR	ADL/MET 0	06.14.22		<i>R</i> 07

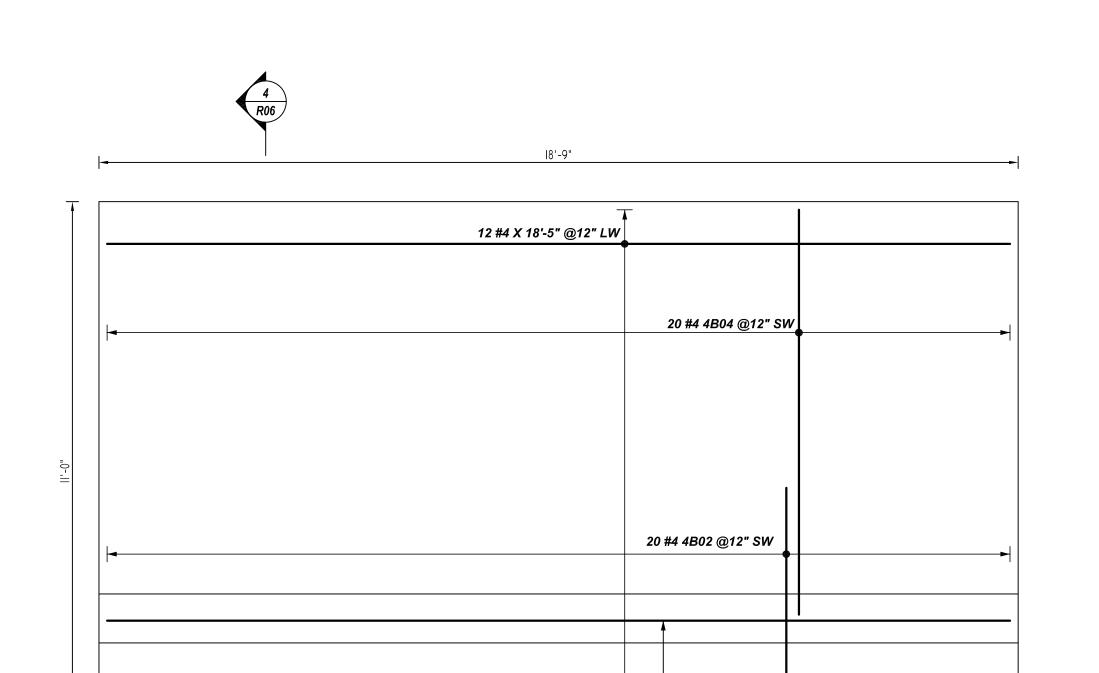

PLAN OF PLAZA STAIR REINFORCEMENT DETAILS REF: C-002 SCALE: 1/2" = 1'-0"

3 #4 X 18'-5" ADD'L CONT..—

----- 4 #4 X 18'-5" NOSING BAR

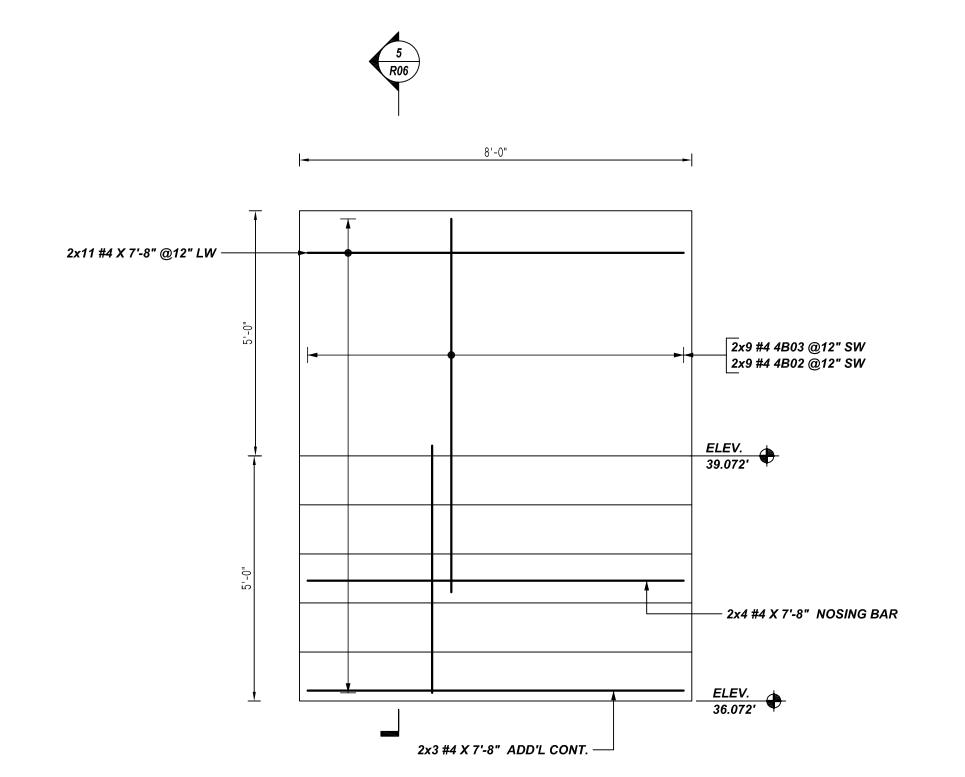

PLAN OF EXTERIOR STAIR REINFORCEMENT DETAILS


REF:C-002 SCALE: 1/2" = 1'-0" SCALE: 1/2" = 1'-0"

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Release Number	Release Number: R08 BENDING DETAILS															
Bar Mark	Qty	Size	Total Length	Туре	'A'	,B,	'C'	'D'	'E'	'F'	'G'	'H'	' J'	'K'	'0'	'R'
4B01	6	#4	4'-4"	17		2'-2"	2'-2"									
4B02	38	#4	6'-2 <i>Y</i> ."	3		4'-0 ½"	2'-2"					1'-11 <i>½</i> "		0'-11 ½"	5'-0"	
4B03	18	#4	8'-1 <i>¼</i> "	3		3'-4"	4'-9 ¼"					2'-2 ¼"		4'-3"	7'-7"	
4B04	20	#4	8'-5 <i>¼</i> "	3		6'-4 ½"	2'-0 ¾"					0'-11 ¼"		1'-10 ¼"	8'-2 ¾"	



LAP SCHEDULE


4000 PSI (CLASS-B) CASE - 1 Per ACI :318 (12.2.2)

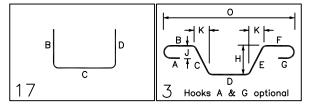
rei Aci .s	10 (12.2.2)					
	LENGTHS					
BAR#	TOP	OTHERS				
#3	2'-0"	1'-7"				
#4	2'-8"	2'-1"				
#5	3'-4"	2'-7"				
#6	4'-0"	3'-1"				
#7	5'-10"	4'-6"				
#8	6'-8"	5'-2"				
#9	7'-7"	5'-10"				
#10	8'-6"	6'-7"				
#11	9'-5"	7'-3"				


ALL TOP BARS ARE DEFINED AS HORIZ BARS WITH MORE THAN 12" OF CONCRETE BELOW BARS.

ALL BARS IN THIS DRAWING ASTM A615 GRADE 60 BLACK UNCOATED

TYPICAL REINFORCING BAR CLEAF	RANCE TABLE
LOCATION	MIN. COVER
FOUNDATION BOTTOM & SIDES	3" CLR
FOUNDATION TOP	2" CLR
PAD SIDES & STAIR	2" CLR

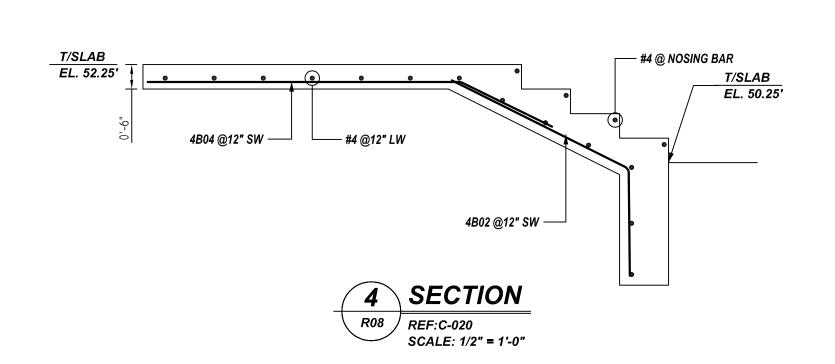

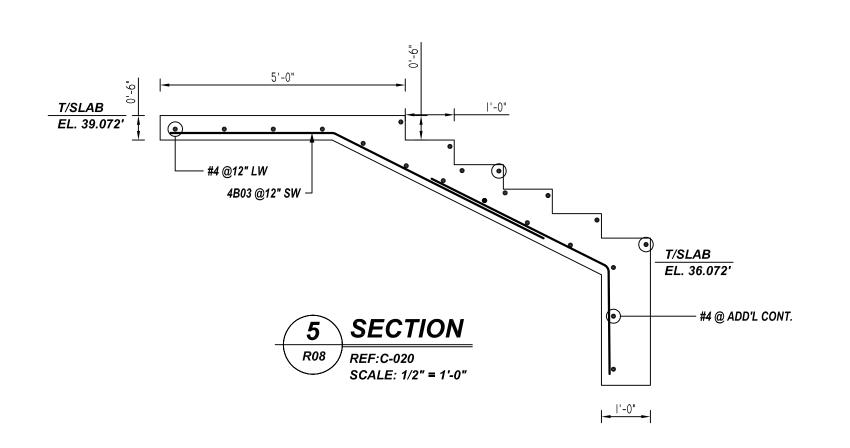

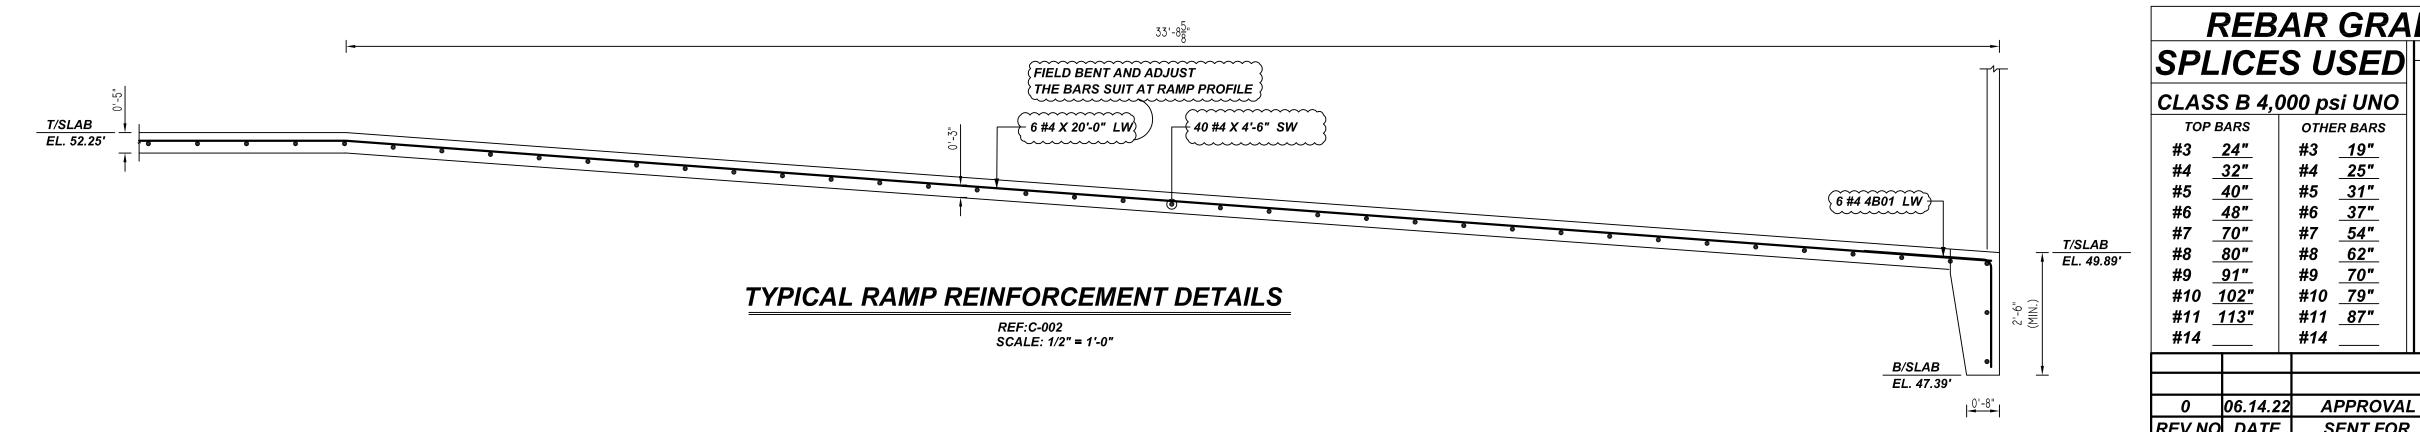

SPLICE	S USED		4	ARK SIZE /ALENT	
CLASS B 4, TOP BARS #3 24" #4 32" #5 40" #6 48" #7 70" #8 80" #9 91" #10 102" #11 113" #14	000 psi UNO OTHER BARS #3 19" #4 25" #5 31" #6 37" #7 54" #8 62" #9 70" #10 79" #11 87" #14	B.O.W. = Bottom of wall C.B. = Corner Bars DIAG. = Diagonal D.O. = Door Opening DWLS. = Dowels E.F. = Each Face E.S. = Each Side E.W. = Each Way FTG. = Footing F.F. = Far Face HORIZ. = Horizontal I.F. = Inside Face INTERS= Intersection L.W. = long Way N.F. = Near Face O.F. = Outside Face S.W. = Short Way T&B = Top & Bottom T.O.W. = Top of Wall Trans. = Transverse VERT. = Vertical	#3 #4 #5 #6 #7 #8 #9 #10 #11	#10 #13 #16 #19 #22 #25 #25 #29 #32 #36	350 cu

CITY OF HYATTSVILLE

SITE WORK REINFORCEMENT DETAILS

SHAMILTON STREET HYATTSVILLE, MD 20782

CUSTOMER:

DESIGNER: COLUMBIA ENGINEERING